AGENDA

City of Hapeville

3468 North Fulton Avenue

Hapeville, Georgia 30354

Design Review Committee

October 16, 2019

6:00 PM

- 1. Welcome And Introduction
- 2. Approval Of Minutes
 - 2.I. DRC Minutes September 18, 2019

Documents:

DRC MINUTES SEPTEMBER 18, 2019.PDF

3. Tony McSwain 3472 Rainey Avenue

Mr. Tony McSwain has submitted updated plans to make minor changes to the front façade of the dwelling at 3472 Rainey Avenue. The property is zoned U-V, Urban Village.

Documents:

3472 RAINEY AVENUE APP.PDF

4. Steve Lamb 3275/3277 Russell Street

Mr. Steve Lamb has submitted an application seeking approval of plans to convert a concrete walkway from the sidewalk to the front door into a wooden wheelchair-accessible ramp to the existing dwelling at 3275/3277 Russell Street. The property is zoned R-2, Two Family Residential.

Documents:

3275-3277 RUSSELL STREET APP.PDF

5. Reuben Buckareff 438 Porsche Avenue

Mr. Reuben Buckareff has submitted an application seeking approval of plans for the addition of a window to the right-side elevation of the existing structure at 438 Porsche Avenue. The property is zoned U-V, Urban Village.

Documents:

438 PORSCHE AVENUE APP.PDF

6. Jimmy Joyner 105 Lilly Street

Mr. Jimmy Joyner has submitted an application seeking approval of plans to construct a new 1,990-square foot single family dwelling with a 442-square foot attached garage at 105 Lilly Street. The property is zoned R-1, One Family Detached.

Documents:

105 LILLY STREET APP.PDF

7. Miller Lowry Developments LLC 591 King Arnold Street

Miller Lowry Developments, LLC has submitted an application seeking approval of plans to construct a new project consisting of 18 townhomes. The property is zoned U-V, Urban Village and is within the A-D, Arts District Overlay.

Documents:

591 KING ARNOLD STREET APP.PDF

8. Joseph Latimer 801 Virginia Avenue

Mr. Joseph Latimer has submitted an application seeking approval of plans for the exterior remodel of the existing 4,962-square foot commercial building located at 801 Virginia Avenue. The property is zoned V, Village and is within the A-D, Arts District Overlay.

Documents:

801 VIRGINIA AVENUE APP.PDF

9. Steven Ellis Porsche Avenue

Mr. Steven Ellis on behalf of Pro Building Systems Inc. has submitted an application seeking approval of plans to construct a new 20,815-square foot automobile service center and repair facility on Porsche Avenue. The property is zoned B-P, Business Park.

Documents:

PORSCHE AVENUE APP.PDF

- 10. Next Scheduled Meeting Wednesday, November 20, 2019 At 6:00PM
- 11. Adjourn

Please note that if the Design Review Committee approves the submitted application with condition(s), the applicant is responsible for making the necessary changes and resubmitting.

Agenda subject to change



Design Review Committee Meeting Minutes

September 18, 2019

I. Call to Order

Jonathan Love called to order the regular meeting of the Design Review Committee at 6:00 PM on September 18, 2019 at Hapeville City Hall Conference Room.

II. Roll Call

Jonathan Love conducted a roll call. The following persons were present Brian Gregory, Karl Dufrenne, John Stalvey, and Michael Smith (non-voting). Rick Ferrero, absent (1).

III. Meeting Minutes

The Committee reviewed the minutes from August 21, 2019. Mr. Stalvey made a motion to approve the minutes. Mr. Dufrenne seconded; motion passed 4-0.

IV. Applications

- a) 438 Porsche Avenue not attending Motion was made by Mr. Love to move the item to the end of the meeting. Mr. Gregory seconded; motion passed 4-0.
- b) 219 Maple Street Daniel Moore attending
 Mr. Gregory made a motion to approve the application with the following requirements:
 - 1. Add a 10-inch beam to the drawing on the gable over the front porch on the front and sides;
 - 2. Revise the drawings to show the additional column;
 - 3. Address all comments in the Planner's report (exclude No. 5, included incorrectly).

The following design exceptions are allowed:

- 4. For the porch width of less than 80% of the enfronting façade due to existing poured concrete porch base;
- 5. For the porch height to be between 2-feet and 4-feet due to the existing poured concrete porch base;
- 6. For the column width to be a maximum 8-feet on center due to existing poured concrete porch base.

Mr. Stalvey seconded; motion passed 4-0.

c) 257 Birch Street - David Cook attending

The applicant provided updated plans addressing all issues in the Planner's report except for item 16 regarding window details. Mr. Dufrenne made a motion to approve the application with the following requirements:

- 1. Keep horizontal slats on front porch as drawn on the supplied plans;
- 2. Mullions between ganged windows must be 2-inches wider than the trim;
- 3. Applicant agreed to keep exposed rafter tails;
- 4. Applicant agreed to update plans to provide window details as defined in Item 16 on the Planner's Report.

The following design exceptions are allowed:

5. For the column width to be a maximum 8-feet on center as the proposed design fits with the intended architectural standard.

Mr. Love seconded; motion passed 4-0.

d) 261 Birch Street - David Cook attending

Mr. Gregory made a motion to approve the application with the following requirements:

- 1. Mullions between ganged windows must be 2-inches wider than the trim;
- 2. Add front porch columns to be 8-feet on center;
- 3. Front porch railings to use vertical picket railings;
- 4. Brick on chimney and columns;
- 5. Board and batten on all gables;
- 6. Add corner boards:
- 7. Add 1x10 trim board above stucco foundation on all sides.

Applicant agreed to all requirements and Mr. Stalvey seconded; motion passed 4-0.

e) 449 Walnut Street - Bernard Vigilance attending

Mr. Gregory made a motion to conditionally approve the application upon staff review of the resubmitted plans addressing all the Planner's Reports items and the following requirements:

- 1. Increase front porch width from 12-feet to meet 80% minimum front-elevation;
- 2. Add additional columns to meet 8-feet on center spacing;
- 3. Update front elevation to add heights from grade to peak.

The committee had the following recommendations:

- 4. On front porch, gang the two single windows and space columns on either side;
- 5. Add window(s) to the rear elevation of garage.

The following design exception is allowed:

6. For the windowsill height to more than 2-feet above the finished floor elevation on the first floor.

- Mr. Dufrenne seconded; motion passed 4-0.
- f) 451 Walnut Street Bernard Vigilance attending

Mr. Love made a motion to conditionally approve the application upon staff review of the resubmitted plans addressing all the Planner's Reports items and the following requirements:

- 1. Reduce front porch width from 12-feet to center column between windows;
- 2. Add additional columns to meet 8-feet on center spacing;

The committee had the following recommendations:

3. Add window(s) to the rear elevation of garage.

The following design exceptions are allowed:

- 4. For the windowsill height to more than 2-feet above the finished floor elevation on the first floor;
- 5. For the minimum porch width to be 80% of the front-elevation.

Mr. Stalvey seconded; motion passed 4-0.

- g) 591 King Arnold Street Miller Arnold Developments attending (Danny and Miles) Mr. Gregory made a motion to table the application until the plans are complete. The applicant agreed to address all the items in the Planner's report. The committee made a recommendation to connect the sidewalks from units 15 and 16 to the brick pathway if reasonably possible. The following design exceptions are allowed:
 - 1. For the minimum first floor height of 12-feet for unit 13-18;
 - 2. For townhouses to have livable space on the first floor for 13-18;
 - 3. For the width of the alley to not exceed 15-feet;
 - 4. For the driveway to be a minimum of 10-feet from the sidewalk on unit 1;
 - 5. For the enfronting façade material of fiber-cement to not be more than 20%;
 - 6. For enfronting sidewalk access for units 14-17;
 - 7. For window shapes to have a vertical height greater than the width on unit 13-18.

Mr. Stalvey seconded; motion passed 4-0.

h) 438 Porsche Avenue - not attending

Mr. Gregory made a motion to table the application until the next scheduled meeting. Mr. Love seconded; motion passed 4-0.

V.	Adjournment Jonathan Love adjou Wednesday, October	rned the meeting at 8:28 PM. 16, 2019.	Next scheduled	meeting is
	Minutes submitted by:	Brian Gregory, Secretary		
	Minutes approved by:	Jonathan Love, Chairman		



DEPARTMENT OF PLANNING AND ZONING PLANNER'S REPORT

DATE: October 11, 2019
TO: Tonya Hutson
FROM: Michael Smith

RE: Design Review – 3472 Rainey Avenue – Façade Changes

BACKGROUND

The City of Hapeville has received updated plans for a new house to be constructed at 3472 Rainey Avenue. The new plans include minor changes to the front façade of the house. The changes include:

- Changing the window grille pattern from two over one to four over four
- Addition of angle brace detail to columns
- Addition of bracket and corbel trim to soffit
- Changing the style of front door

The designs are otherwise identical to those of the approved application.

RECOMMENDATION

The proposed changes are compliant with the Architectural Design Standards and are consistent with the approved style. Staff recommends approval.

3472 Rainey Avenue

1. The overall height of the existing structure.

Height of existing: 16'- 6" measured from the ground near the front door to the roof ridge. (*Page. 2AB-1*)

2. The distance bet ween the existing home and the addition and the property line.

The existing west setback is 1.36'. The new west setback is 8.76'. The exist i ng east setback is 8.03' and it stays 8.03'. (*Page: C-1*)

3. A sidewalk adjacent to Moreland Way. (Done, review Landscaping Plan)

We will inst all 3000-3500 PSI Concrete for the sidewalk . 4' wide sidewalk or equal to surrounding sidewalk near neighborhood. 4" thick. 4" of gravel underneath concrete. 8' control Joints 1" deep cuts.

4. A landscape plan for the property, including street trees adjacent to Moreland Way.

(Done, review Landscaping Plan)

5. Removal and/ or screening of existing chain link fencing visible from the street.

Yes, we can conceal the chain link fence with landscaping or build a privacy wood fence using I"x6"x6' Cedar. (Page: C-1)

6. The location and screening of mechanical equipment.

(Done, review Landscaping Plan)

7. A light adjacent to the front door.

Added (Page: 3A-3) & ((Page: 3A-3)

8. The widt h of the existing driveway.

Driveway width: 7.53' at its narrowest to 7.99' at its widest. (Page: C-1)

9. Information pert ai ning to the manufacturer's warranty related to the architectural shingles.

Add to the Plans (Page: I A-2)

10. Information pertaining to the material and finish of the gutters and downspouts.

Gutters-6" White Aluminum Gutters. (Amerimax Model #4600200120)

Downspouts- 3"x4" White Aluminum Downspouts (Amerimax Model #4601100120)

Gutter hangers- 6" Aluminum Hidden Hangers (Spectra Metals Model #6HRHHAL). (Page: 3A-2)

11. The depth of the existing front porch.

The existing front setback (to the covered porch) is 28.86' and it stays 28.86'. (Page: IAB-1)

12. The finish and materials of the portion of the front porch visible from the street


Hardie Siding 5/16"x 8 1/4" fiber cement (James Hardie Model #215518)

Trim 1"x4"x16' primed Finger- Joint Board (Model# 702636) Body and Trim will be painted to customers choice in color."

13. Building numbers on the front elevation. (Page: 3A-3)


Added


Change window grille pattern from 2 over one to four over four Add angle brace detail to columns
Add bracket and corbel trim to soffit

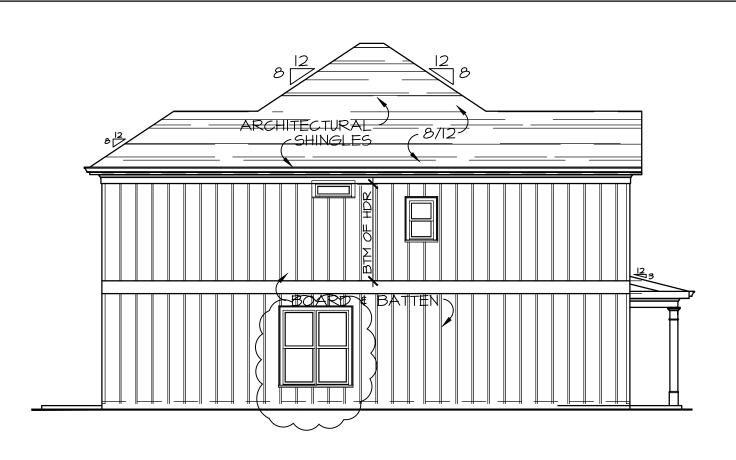

LEFT ELEVATION


 $\overline{\text{SCALE: } 1/8" = 1'-0"}$

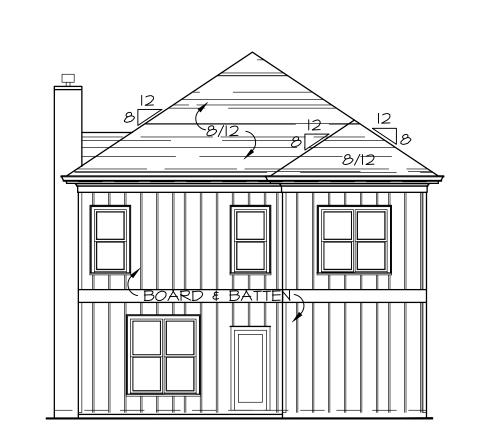

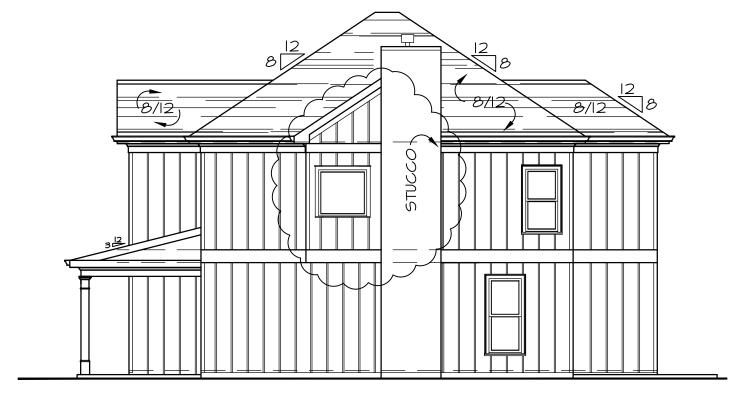

RIGHT ELEVATION

 $\frac{}{\text{SCALE: }1/8" = 1'-0"}$

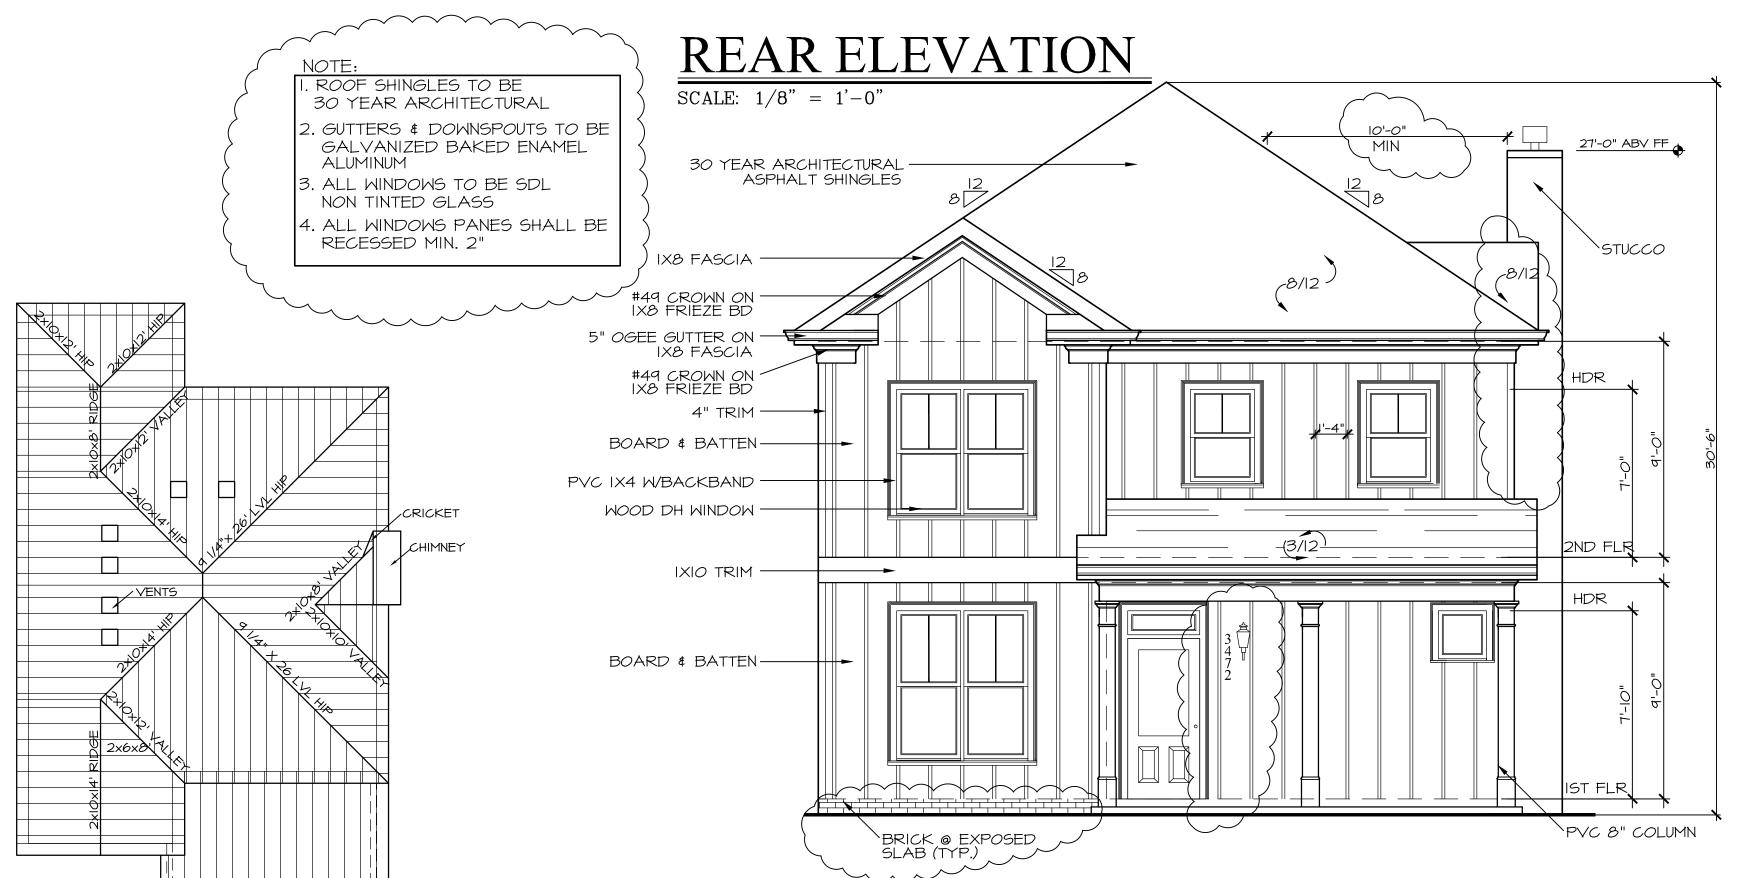

ROOF PLAN SCALE: 1/8" = 1'-0"

FRONT ELEVATION

SCALE: 1/4" = 1'-0"

A Z Development Company, Inc.

Designer*Builder POBOX 1326 MABLETON, GA 30126 (678) 2 3 4 - 8 0 9 4

USONIAN HOMES

Drawn By: R. BETHELY 4/15/2019 Project No:

NOTED Scale:

V

47


3

PLAN ROOF

ELEVATIONS


Sheet Title: EXTERIOR

|Sheet:

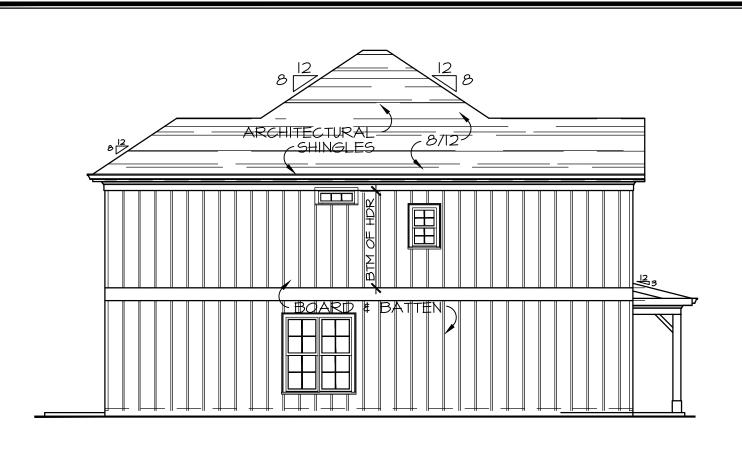

LEFT ELEVATION

SCALE: 1/8" = 1'-0"

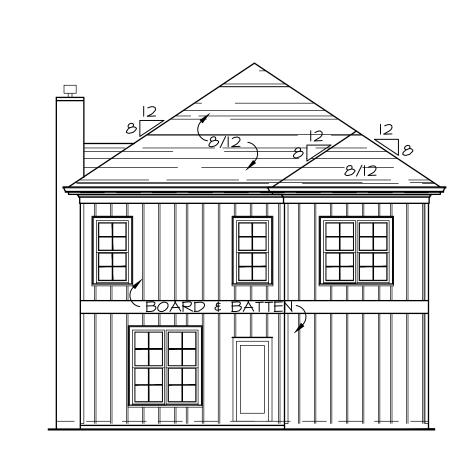




RIGHT ELEVATION


8" COLUMN

 $\frac{}{\text{SCALE: } 1/8" = 1'-0"}$

NOTE:

- ROOF SHINGLES TO BE 30 YEAR ARCHITECTURAL
- 2. GUTTERS & DOWNSPOUTS TO BE GALVANIZED BAKED ENAMEL ALUMINUM
- 3. ALL WINDOWS TO BE SDL NON TINTED GLASS
- 4. ALL WINDOWS PANES SHALL BE RECESSED MIN. 2"

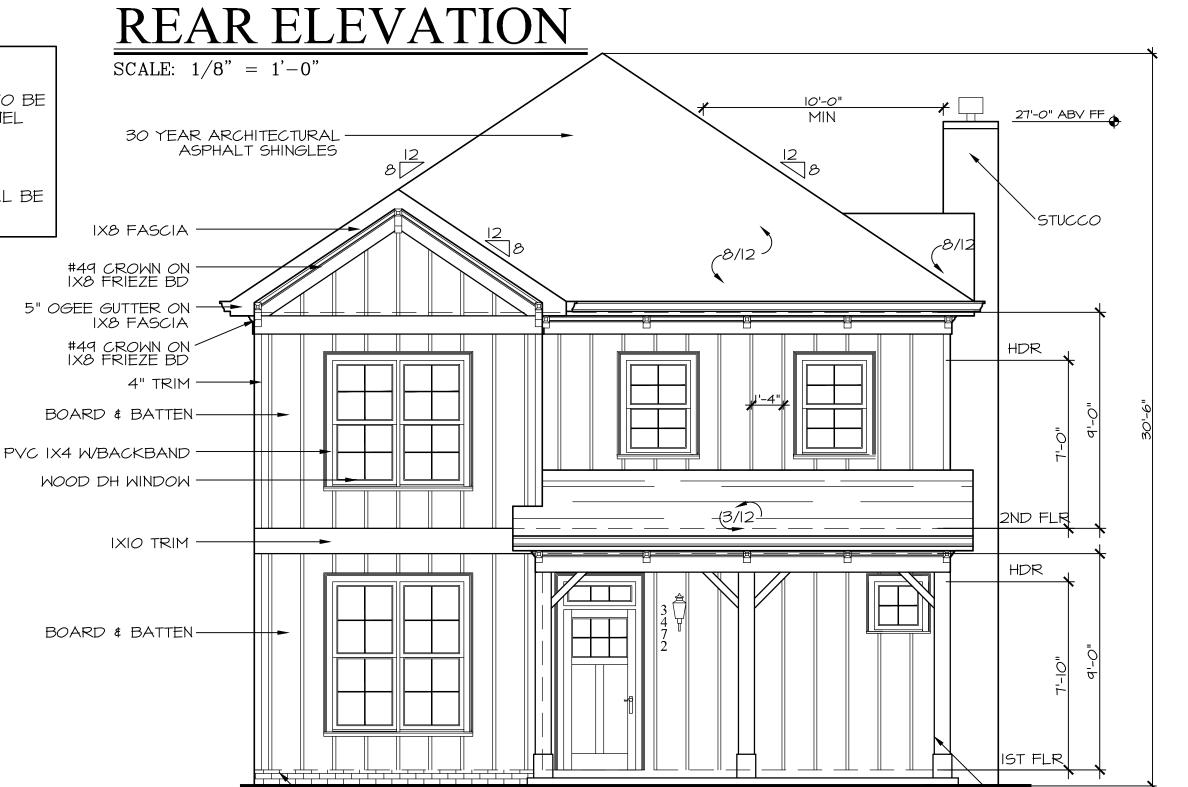

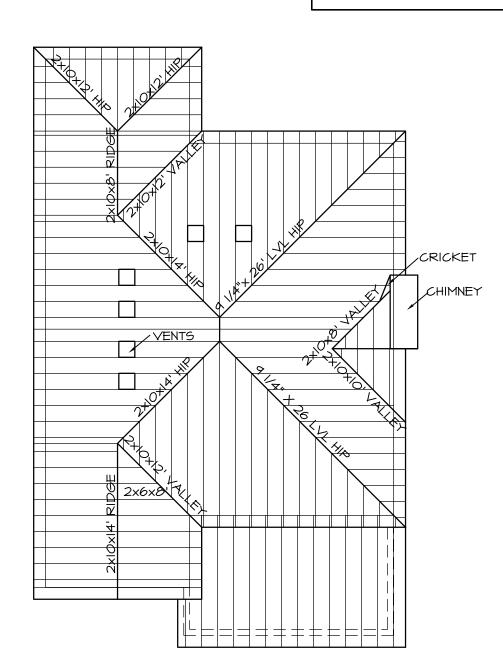

ROOF PLAN SCALE: 1/8" = 1'-0"

FRONT ELEVATION

SCALE: 1/4" = 1'-0"

BRICK @ EXPOSED SLAB (TYP.)

A Z Development Company, Inc. Designer*Builder POBOX 1326 MABLETON, GA 30126

(678) 2 3 4 - 8 0 9 4

USONIAN HOMES

Drawn By: R. BETHELY 4/15/2019 Project No:

NOTED Scale:

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PLAN ROOF 8 ELEVATIONS

Sheet Title: EXTERIOR

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DEPARTMENT OF PLANNING AND ZONING PLANNER'S REPORT

DATE: October 11, 2019
TO: Tonya Hutson
FROM: Michael Smith

RE: Design Review – 3275-3277 Russell Street – Wheelchair Ramp

BACKGROUND

The City of Hapeville has received a design review application from Steve Lamb and Wilbur Lamb to convert a concrete walkway from the sidewalk to the front door into a wooden wheelchair-accessible ramp for an existing single-story single-family dwelling at 3275/3277 Russell Street.

The property is zoned R-2 – Two-Family Residential, and is subject to the Neighborhood Conservation Area, Subarea E of the Architectural Design Standards.

RECOMMENDATION

The Architectural Design Standards do not provide guidance for the installation of wheelchair ramps. As wheelchair ramps are not directly allowed by the code, a Design Exception would be required. If approved, staff recommends requiring the ramp to be painted or stained in accordance with the front porch requirements of the Standards.

CITY OF HAPEVILLE DESIGN REVIEW APPLICATION

SUBMITTAL	DATE: 09/16/2019		
NOTE: All applications must be typed or neatly printed. Applications authorized representative is required to personally appear at the Design Meeting to answer questions.			
	Every attempt will be made to place month's agenda following the sul	ets the third Wednesday of each month. se your application for review on the next bmittal of a completed application with at may not always be possible. The City tions as deemed necessary.	
Applicant: S	teve Lamb/WILBUR &. LAMB	Contact Number:	
Applicants Ad	dress: 3		
		Zoning Classification: Residential 1/2-0	
Address of Pro	oposed Work: 3277/3275 Russell Stree	et Hapeville GA 30354	
Parcel ID# (INF	FORMATION MUST BE PROVIDED): 12	1009500100757	
Property Owner:			
Project Desc	ription (including occupancy type):	Replace unlevel concrete walkway with a	
		wooden handicap accessible ramp.	
Contractors	Name: Self performed	Contact Number:	
Contact Pers	son:	Contact Number:	
property. I do accurate, and I application and reserves that rig I further unders full. I hereby accurate the Englis voluntarily com	hereby swear or affirm that the information I understand that any inaccuracies may be any action taken on this application. I ght to enforce any and all ordinances regardstand that it is my/our responsibility to concknowledge that all requirements of the Citysh language and/or this document has been pleted this application. I understand that it	esign Review Committee for the above referenced in provided here and above is true, complete and se considered just cause for invalidation of this understand that the City of Hapeville, Georgia, dless of any action or approval on this application. If form with all of City of Hapeville's Ordinances in y of Hapeville shall be adhered to. I can read and en read and explained to me and I have full and is a felony to make false statements or writings to and I may be prosecuted for violation thereof.	
Applicants	Signature	Date	

Proj	ect Class (check	one):	
X	Residential	Commercial	Mixed-Use Development
Proj	ect Type:		
	New Commercial	Construction	Addition to Existing Commercial Building
	Addition to Existin	ng Residential Structure	Accessory Structure
	Site Plan, Gradin	g & Landscaping	New Single Family Residential Construction
<u>X</u>	Other _ Handicar	o ramp at front entrance of re	esidential structure
Tota	l Square Footage of	proposed New Construction	on: 21' long x 54" wide
Tota	l Square Footage of	existing building:	
Estir	mated Cost of Const	ruction: approx \$900 in ma	terials
	-	aterials on the exterior of the indsor railing with twisted sp	ne existing structure:
th	nis type of railing is no	ot intended for installation m	ore than 30-in off the ground.
(See Lowes Home Imp	provement Item # 14252 Mo	del #574)
	Existing walkway is po	oured concrete (appox 3" thi	ck)
-			
	•		exterior facade of the new structure:
	lew ramp, railing, and	spindles are to be pressure	e treated lumber

			· · · · · · · · · · · · · · · · · · ·

NOTICE

Please be advised that the Community Service Department is here to assist all applicants regarding application procedures, meeting schedules and necessary deadlines. The Community Service Department does NOT make any final decisions for the Design Review Committee, Sign Committee, Planning Commission, Board of Appeals or rezoning request to Mayor and Council.

A complete application must be submitted before the Community Service Department will accept an application and forward the same to the appropriate entity.

Building inspections issued by the City of Hapeville are contracted out to State of Georgia Certified Inspectors. These inspectors make the final decisions regarding building, electrical, plumbing and HVAC work completed in the City of Hapeville. The Hapeville Fire Marshal conducts inspections issued through the Community Services Department as needed. Both the Certified Inspectors and Fire Marshal make the final decisions before Certificates of Occupancy's are issued.

Please be advised that the Community Service Department shall not be responsible for your purchasing materials, equipment, items, signs, etc... before you receive final approval by any entity whose approval is required.

I understand that it is a felony to make false statements or writings to the City of Hapeville, Georgia pursuant to O.C.G.A. 16-10-20 and I may be prosecuted for a violation thereof.

(Please Print & Initial)

swear or affirm that before receipt of an application, I have received this notice and I read and write the English language or I have had someone read and explain this document to me.



DEPARTMENT OF PLANNING AND ZONING


DESIGN REVIEW APPLICATION INSTRUCTIONS AND ACKNOWLEDGEMENT


I, the undersigned, agree that wifollowing:	ith my signature and submission to t	he City of Hapeville, I have done the
proposed project. The Architect	s Architectural Design Guidelines and ural Design Guidelines may be found	here:
nttps://library.municode.com/ga	a/hapeville/codes/code of ordinand	ces modeld = PTIICOUR CH81ARDEST
Ensured that my proposed of Ordinances.	project meets all of the required cri	teria per the City of Hapeville Code
Submitted my application no Design Review Committee meet	naterials in full by the published deading.	dline for review by Staff prior to the
	deficiencies or components of the p in the Code. This explanation should	
	encies in the application must be res ing or the application may not be pre	
Submitted architectural dra Community Services or Planning	wings and details for all projects unloading Department.	ess allowed in writing by the
	red revisions by the Design Review C	
	oust follow approved plan and that to ection is performed and Architectu	
WILBUR S. LA	mB	09/16/2019
Printed Name	Signature	Date


Should you have any questions, please do not hesitate to contact the Community Services Department at 404-669-2120.

Thank you for interest and investment in the City of Hapeville.



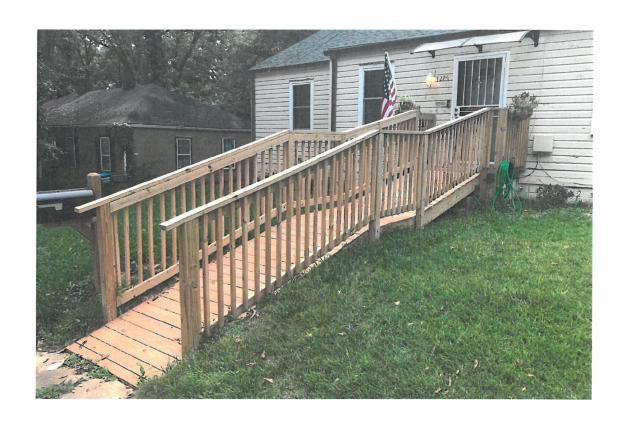

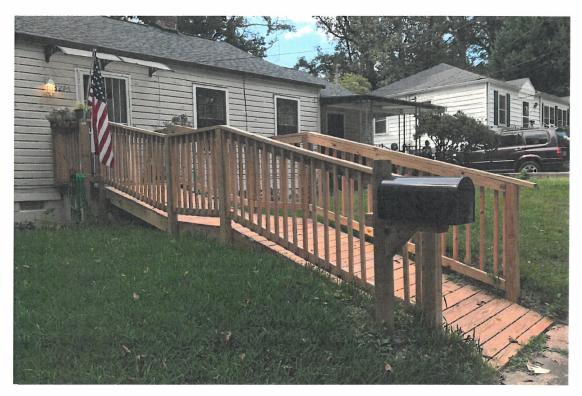

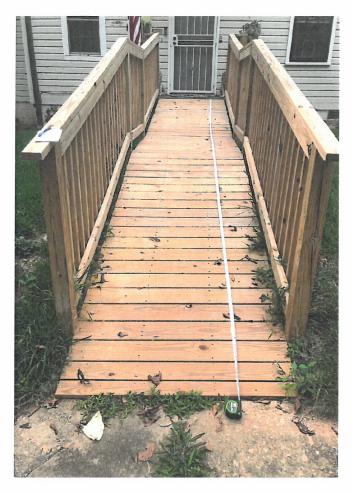


















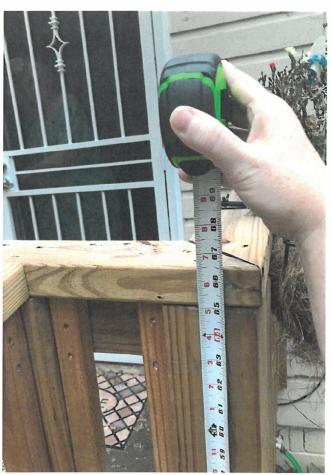











DEPARTMENT OF PLANNING AND ZONING PLANNER'S REPORT

DATE: September 13, 2019
TO: Tonya Hutson
FROM: Lynn Patterson

RE: Design Review – 438 Porsche Avenue – Window Addition

Not Applicable:

BACKGROUND

The City of Hapeville has received a design review application from Reuben Buckareff for the addition of a window to the right-side elevation of an existing structure at 438 Porsche Avenue. The applicant states the window opening was pre-existing but had been bricked in from the outside.

The property is zoned U-V, Urban Village and is subject to the Commercial/Mixed-Use area, Subarea B, of the Architectural Design Standards.

CODE

SEC. 81-1-6. COMMERCIAL/MIXED-USE AREA

(h) Door and window standards.

- O The main entry door to enfronting principal buildings shall face, be visible from, and be accessible from the adjacent public sidewalk.
- O The main entry door to all uses shall be linked to the sidewalk via a pedestrian walkway or wheelchair access.
- Sirst-story doors or windows operating on sliders are only permitted when they open directly onto a required sidewalk or supplemental zone.
- O Building numbers, at least six inches in height, shall be located above or beside the street-facing pedestrian entrance.
- Window panes serving commercial uses shall be recessed a minimum of three inches and a maximum of eight inches from the adjacent facade.
- O Where window lights are utilized they shall be true divided lights, simulated divided lights, or one-over-one lights. Grids between glass are prohibited.
- O Where used, window shutters shall match one-half the width of the window opening.
- ✓ Enfronting windows shall be vertically shaped with a height greater than width, including display windows but not transoms.

- O Enfronting windows and door glass (except on churches and fire stations) shall utilize clear glass or tinted glass. Tinted glass shall have a transmittance factor of 50 percent or greater and shall have a visible light reflectance factor of ten or less.
- O Painted window or door glass is prohibited.
- All enfronting "storefront and awning" treatments identified in Figure 3, and all enfronting facades along Atlanta Avenue, North Central Avenue, South Central Avenue, Virginia Avenue, Dogwood Drive (except within subarea C), and Sylvan Road shall provide a storefront consisting of:

A nonglass base or knee wall beginning at grade and extending not more than 24 inches above the sidewalk.

A glass display window beginning at the top of the bulkhead or knee wall, to a height not less than ten feet and not more than 12 feet above the adjacent required sidewalk. Such glass shall provide views into display windows having a minimum depth of two and one-half feet and that are accessible from the building interior.

A main entry door remaining unlocked during normal business hours, and having a surface area that is a minimum of 70 percent glass.

A glass transom located above the glass display window having a minimum height of 18 inches and a maximum height of 36 inches.

A minimum of 75 percent of the length of the enfronted portion of the build-to line shall be provided in glass, including glass doors and display windows

No linear distance of more than ten feet without intervening glass display windows or glass doors.

First-story drop ceilings recessed a minimum of 18 inches from the display window opening.

Awnings projecting from buildings, serving as an entry canopy and/or providing identification to the business, are allowed, provided that:

Awnings shall be at least five feet deep as measured from the building's front facade.

Awnings serving as an entry canopy shall match adjacent business awnings in depth and height.

Valance width and height must align horizontally.

Frame construction on awnings should be square aluminum tubes. Thin, one-and-one-half-inch-diameter round aluminum tube frames are not permitted. It is suggested that Steel Stitch™ brand be used.

Valance on awnings should always be loose as valances should not be rigidly framed.

Approved awnings may be externally lighted with light fixtures in keeping with the style of the building, as approved by the DRC.

Light fixtures in awnings may light the ground surface or storefront below, however, light fixtures may not be visible from the public right-of-way.

Internally, back lit awnings, where the lights actually illuminate the awning fabric, are prohibited.

Signs on awning must meet all requirements of the sign ordinance.

No changes are proposed to the enfronting façade.

NOTES:

• The applicant should provide the depth of the installed windowpane from the adjacent façade.

RECOMMENDATIONS

Windowpanes in the Commercial/Mixed-Use area must be recessed between three and six inches from adjacent facades. The applicant should provide the recession of the installed window. Once this has been provided and the condition has been satisfied, the application can be approved.

CITY OF HAPEVILLE DESIGN REVIEW APPLICATION

SUBMITTAL	DATE: Sep 11, 2019		
NOTE:	All applications must be typed or neatly printed. Applications or a authorized representative is required to personally appear at the Design Review Meeting to answer questions.		
	Every attempt will be made to month's agenda following the supporting documents; however	re meets the third Wednesday of each month. To place your application for review on the next e submittal of a completed application with er, that may not always be possible. The City pplications as deemed necessary.	
Applicant: Re	euben Buckareff	Contact Number:	
Applicants Ad	dress: 438 Porsche Ave, Ha	peville GA 30354	
E-Mail Address	s:	Zoning Classification: Commercial	
Address of Pro	pposed Work: 438 Porsche A	ve, Hapeville GA 30354	
Parcel ID# (INF	FORMATION MUST BE PROVIDED): <u>14 009600050191</u>	
Property Owne	er: TL Hughes LLC.	Contact Number:	
in side of bu		ype): Office renovation - Adding window sly been in the exact same area but had utside.	
	Name: Reuben Buckareff	Contact Number:	
I hereby make a property. I do I accurate, and I application and reserves that rig I further unders full. I hereby acwrite the Englis voluntarily comp	pplication to the City of Hapeville, to hereby swear or affirm that the information understand that any inaccuracies any action taken on this application to enforce any and all ordinances tand that it is my/our responsibility knowledge that all requirements of the language and/or this document holeted this application. I understand	the Design Review Committee for the above referenced mation provided here and above is true, complete and may be considered just cause for invalidation of this on. I understand that the City of Hapeville, Georgia, regardless of any action or approval on this application. to conform with all of City of Hapeville's Ordinances in the City of Hapeville shall be adhered to. I can read and as been read and explained to me and I have full and that it is a felony to make false statements or writings to 5-10-20 and I may be prosecuted for violation thereof.	
Applicants S	Signature	Date	

Residential	Commercial	Mixed-Use Development
Project Type:		
New Commercial	Construction	Addition to Existing Commercial Bui
Addition to Existing	ng Residential Structure	Accessory Structure
Site Plan, Gradin	g & Landscaping	_New Single Family Residential Construc
Other		
Total Square Footage of	proposed New Construction	on:
Total Square Footage of	existing building: 2,650	
Estimated Cost of Constr	ruction: \$1150	
	aterials on the exterior of the	
		ne existing structure:
Cement block		
Cement block List/Describe Building Ma		exterior facade of the new structure:
Cement block List/Describe Building Ma	aterials proposed for the e	exterior facade of the new structure:
Cement block List/Describe Building Ma	aterials proposed for the e	exterior facade of the new structure:
Cement block List/Describe Building Ma	aterials proposed for the e	exterior facade of the new structure:

NOTICE

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I <u>Recber Buckare 1</u> swear or affirm that before receipt of an application, I have received this notice and I read and write the English language or I have had someone read and explain this document to me.

(Please Print & Initial)



DEPARTMENT OF PLANNING AND ZONING

DESIGN REVIEW APPLICATION INSTRUCTIONS AND ACKNOWLEDGEMENT

I, the undersigned, agree that with my following:	y signature and submission to the City	of Hapeville, I have done the
proposed project. The Architectural D	nitectural Design Guidelines and relevan Design Guidelines may be found here: eville/codes/code of ordinances?nod	
Ensured that my proposed proje of Ordinances.	ect meets all of the required criteria pe	er the City of Hapeville Code
Submitted my application materi Design Review Committee meeting.	als in full by the published deadline for	r review by Staff prior to the
	iencies or components of the proposed Code. This explanation should be sub	
	s in the application must be resolved a the application may not be presented	
Submitted architectural drawings Community Services or Planning & Zon	s and details for all projects unless allo ning Department.	wed in writing by the
	evisions by the Design Review Committeent for review prior to requesting any processing and proc	
	ollow approved plan and that the Cert on is performed and Architectural Desi	
Reuben Buckaroff		Sea 11,2019
Printed Name	Signature	Date
	1	

Should you have any questions, please do not hesitate to contact the Community Services Department at 404-669-2120.

Thank you for interest and investment in the City of Hapeville.

Property Profile for 438 HENRY FORD II AVE

Property Tax Information

Tax Year 2020

 Parcel ID
 14 009600050191

 Property Address
 438 HENRY FORD II AVE

 Owner
 TLHUGHES LLC

Mailing Address 671 STILL BRANCH DR CANTON

GA 30115

Total Appraisal \$226,700 Improvement Appraisal \$116,400 Land Appraisal \$110,300 Assessment \$90,680 Tax District 30Z Land Area 0.4821 ac **Property Class** Commercial Lots Land Use Class Rail/Bus/Air Terminal

TAD Hapeville TAD

CID

Zoning

Zoning Class not available

Overlay District

2035 Future Development not available

Political

Municipality Hapeville Commission District 6

Commission Person Emma I. Darnell

Council District LRG

Council Person Travis Horsley, Mark Adams, Chloe

Alexander

Voting Precinct HP01
Poll Location Hoyt Smith Center, 3444 N Fulton

Ave

Congressional District 005 State Senate District 036 State House District 060

School Zones

Elementary School Hapeville
Middle School Paul D West
High School Tri-Cities

Other Information

Zip Code 30354
Census Tract 108
In Less Developed Census Tract No

Aerial View



Property Map




Vicinity Map







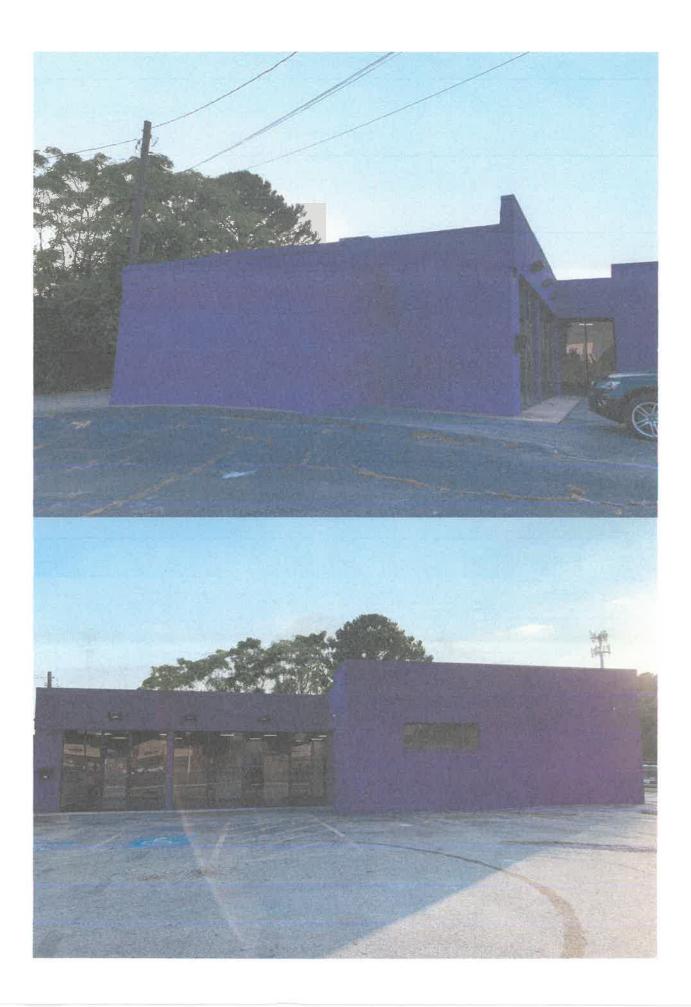



DEPARTMENT OF PLANNING AND ZONING PLANNER'S REPORT

DATE: October 11, 2019
TO: Tonya Hutson
FROM: Michael Smith
RE: Design Review – 105 Lilly Street, Revision 2

Key:

Compliant:
Not Compliant:
Incomplete:

BACKGROUND

The City of Hapeville has received a second revised design review application from Jimmy L. Joyner to construct a new two-story single-family dwelling at 105 Lilly Street. The dwelling will have 1,990 SF of living area and a 442 SF attached garage. It will include three bedrooms and three and a half bathrooms.

Not Applicable:

0

The property is zoned R-1, One-Family Residential and is subject to the Neighborhood Conservation Area of the Architectural Design Standards.

CODE

SEC. 81-1-7. NEIGHBORHOOD CONSERVATION AREA

Based on goals established in this chapter, the following standards are required in the neighborhood conservation area identified in section 81-1-3. This includes two subareas: subarea D and subarea E. All of the standards contained in this section shall apply to all development in all subareas. Subarea requirements are found within the applicable subsection.

This section shall govern subarea C of the commercial/mixed-use area. It may also govern one-family detached dwellings and two-family dwellings in the commercial/mixed-use area, provided that the section is applied in its entirety.

(a) Site development standards

- Except where indicated, setbacks shall be established by zoning.
- On corner lots the principal building shall be located adjacent to the street intersection, subject to setback or build-to line requirements of zoning.
- Minimum building heights shall be established by zoning.
- Within subareas D and E maximum building heights shall be as established by zoning, except that:

Where this chapter provides a more-stringent standard as compared to the zoning code, the more-stringent standard shall prevail. The only exception to this shall be a use grandfathered under the zoning code.

Portions of buildings equal to or less than five feet from a side or rear lot line shall be limited in height to the greater of 16 feet.

Portions of buildings between five and ten feet of a side or rear lot line shall be limited in height to the greater of 25 feet.

Portions of buildings ten feet or greater from a side or rear lot line shall be limited in height to 35 feet.

- Outside of subareas D and E maximum building heights shall be as established by zoning.
- All buildings shall provide first-story occupiable space, for the first ten feet of building depth along the enfronting facade.
- Sidewalks shall be located along all public and private streets. Sidewalks shall consist of two areas: a landscape area and a clear area.
 - Developments less than one acre shall provide a minimum one-foot landscape zone and a minimum four-foot clear zone.

Development of one acre or more shall provide a minimum two-foot landscape zone and a minimum five-foot clear zone.

The above notwithstanding, multifamily developments and all developments along Dogwood Drive shall provide a minimum five-foot landscape zone and a minimum six-foot clear zone.

STAFF COMMENT:

(b) Supplemental Area and Fence Standards

- Developments shall locate landscape supplemental areas adjacent to first-story residential uses and place a minimum of one tree every 50 feet in the supplemental area. See list of allowed trees in section *93-2-14*.
- O Chain link fencing is not permitted in areas visible from a public right-of-way.
- On all lots a fence, wall, curb or hedge between six and 48 inches in height is encouraged at the back of the required sidewalk, except at openings to access steps, drives or pedestrian walkways.
- Fences adjacent to the street shall be picket-wood, stone, composite materials or ornamental metal, with the finished side facing the street.
- Retaining walls adjacent to the required sidewalk shall not exceed 32 inches in height unless required by topography.
- All street-facing walls shall be faced with stone, brick, or smooth stucco.
- Small planting between retaining walls and the required sidewalk are encouraged and should have a minimum width of six inches.

STAFF COMMENT:

(c) Utility Standards

- Mechanical features shall not be located in the supplemental area or front yard and shall be screened from view from any park or along any public right-of-way with planting, walls or fences of equal or greater height. Acceptable materials for screening shall include those materials found in subsection (f)1., provided they are compatible with the principal structure.
- When located on rooftops, mechanical features shall be incorporated in the design of the building and screened with materials similar to the building.
- Street lights may be provided by the developer in an effort to maintain a safe, walkable and well-lit public area throughout the city; pedestrian-scale street lights as approved by the DRC and the department of community services shall be provided by the developer, subject to site plan and design review in new development.
- All developments shall provide a light at the front door. Lighting designed to illuminate the path to the front

door is allowed. Spotlighting may be provided as long as it is properly shielded and does not become an annoyance to adjacent property owners or the public. General area illumination with oversized flood lights is prohibited. Specifically, lighting shall be shielded so that the source of light is not visible from adjacent properties or the public right-of-way.

○ Trees shall not be planted directly above storm drains.

STAFF COMMENT: • A light at the front door should be included in plans.

(d) Parking and Traffic Standards

- One-family detached dwellings and two-family dwellings shall meet the following requirements:
 - ✓ Driveways shall have a minimum width of nine feet and a maximum width of 15 feet.

Circular drives are permitted.

A grass strip in the middle of driveways is encouraged.

All other buildings shall meet the following requirements:

Parcels are permitted a maximum of one driveway curb cut per street. In cases where a property abuts multiple streets the total number of curb cuts or portions thereof may be allocated to a single street.

Driveways shall have a maximum width of 12 feet for one-way and 24 feet for two-way.

Two curb cuts serving two one-way driveways shall be counted as one curb cut.

Public or private alleys, or driveway providing vehicular access to two or more parcels shall not constitute a curb cut.

New public streets shall not count as curb cuts.

Parcels are permitted a maximum of one driveway curb cut per street frontage. In cases where a property abuts multiple streets the total number of curb cuts or portions thereof may be allocated to a single street.

Carports are only permitted subject to the following requirements:

Carports shall be located in the rear or side yard, but shall not be visible from a public right-of-way.

Carport roofs shall be supported by columns with a minimum width and depth of eight inches.

The base of carport columns shall be faced in stacked brick or stacked stone to a minimum height of three feet above grade.

- On-site parking shall be prohibited in the supplemental areas. This shall not be interpreted as restricting onstreet parking located along a public street.
- Garage access on single-family lots shall be prohibited in the front yard of the home.

STAFF COMMENT:

(e) Roof and Chimney Standards

- Principal building roofs for one-family detached dwellings shall have a minimum usable life of thirty (30) years, per manufacturer's warranty.
- ✓ Roof shingles shall be slate, cedar, or asphalt.
- O Roof tiles shall be clay, terra cotta or concrete.

Allowed on one-family and two-family detached dwellings;

Permitted on multifamily and townhouse dwellings only when screened form the adjacent street by a parapet wall.

✓ Gutters shall be copper, aluminum or galvanized steel.

- ✓ Downspouts shall match gutters in material and finish.
- ✓ Roof forms shall be based on architectural style.
- All roofs, excluding dormers, shall overhang a minimum of 12 inches beyond the facade.
- O Dormers are permitted on all style homes (unless specified), but shall not be taller than the main roof to which they are attached.
- Ohimneys exposed to the public view may not be faced in wood or cement based siding and may not be of an exposed metal or ceramic pipe. All chimneys shall be wrapped in a brick, stone or suitable masonry finish material.
- O Chimneys on exterior building walls shall begin at grade.
- Ohimneys shall begin at grade and be faced with brick or stacked stone; extend chimneys between three and six feet above the roof line.

(f) Street Facing Facade and Style Standards.

Exterior facade materials shall be limited to:

Full-depth brick;

Natural or cast stone;

✓ Smooth natural-wood siding and/or cement-based siding;

Shake siding;

Painted fish-scale style shingles, but only when used in front gables;

True, smooth hard-coat stucco, provided that its use is limited to gables of Tudor revival-style buildings.

✓ Exterior building materials shall not be:

Simulated brick veneer, such as Z-Brick;

Exterior insulation and finish systems (EIFS);

Exposed concrete block;

Metal siding or other metal exterior treatment;

Glass curtain walls;

Liquid vinyl;

T-1-11 siding;

Vinyl siding, except that existing one-family detached homes with vinyl siding covering more than 70 percent of the exterior facade may replace said siding or construct an addition faced in vinyl siding.

- Facade materials shall be combined horizontally, with the heavier below the lighter.
- ✓ Blank, windowless walls are prohibited along all facades. See subsection 81-1-7(g)11.
- Foundations shall be constructed as a distinct building element that contrasts with facade materials. Foundations that are exposed above the ground, must be parged with cement, stuccoed over or be faced in brick, natural stone, or cast stone.
- ✓ All exterior stair risers visible from a street shall be enclosed.
- Porches, stoops, and balconies may be located in the front or side yard.
- Porches, stoops, and balconies along front and side building facades shall not be enclosed with screens, plastics, or other materials that hinder visibility and/or natural air flow.
- Porches, stoops, and balconies shall be made of painted or stained wood, stone, brick, or ornamental metal, subject to the additional restrictions below.

- Wooden porches, stoops, and balconies shall provide top and bottom horizontal members on railings. The top railing shall consist of two elements. The upper element shall measure two [inches] by six inches and the lower element shall measure two [inches] by four inches. The bottom railing shall measure two [inches] by four inches.
- Front porches and front stoops of principal buildings shall face and be parallel to the front lot line or build-to line
- ✓ Porch and stoop foundations shall be enclosed.
- Front and side porches and stoops shall not have unpainted, unstained or otherwise untreated or exposed pressure treated lumber along the building line that abuts a public right-of-way.
- Balconies shall have not less than two clear unobstructed open or partially open sides. Partially open is to be constructed as 50 percent open or more. The total combined length of the open or partially open sides shall exceed 50 percent of the total balcony perimeter.
- Stoops and porch[es] shall be a minimum of two feet and a maximum of four feet from grade to the top of the stairs, unless existing topography is greater.
- Stoops shall provide a minimum top landing of four feet by four feet.
- Stoop stairs and landings shall be of similar width.
- Stoops may be covered or uncovered.
- When provided, porches shall have a minimum clear depth of eight feet from building facade to outside face of column.
- Front porch widths shall be between 80 percent and 100 percent of the adjacent facade.
- Side porch widths (including wraparound porches) shall be between 25 percent and 100 percent of the adjacent facade.
- O Enfronting porches may have multistory verandas, living space, or balconies above.
- Y Porch columns shall be spaced a maximum distance of eight feet on center.
- Front porch columns shall have foundation piers extending to grade.
- ✓ All porches shall be covered.
- Enfronting balconies are only permitted on attached or detached one-family home facades when porches are not provided on said facades.
- O Enfronting balconies shall have a minimum clear depth of four feet.
- O Enfronting balcony widths shall be between 25 percent and 100 percent of the adjacent facade.
- Balconies may be covered or uncovered.

(g) Door and window standards.

- The main entry door to enfronting principal buildings shall face, be visible from, and be accessible from the adjacent public sidewalk.
- The main entry door to all uses shall be linked to the sidewalk via a pedestrian walkway or wheelchair access.
- Building numbers at least six inches in height shall be located above or beside the street-facing pedestrian entrance, or above or beside the stairs accessing a front porch.
- O Doors that operate as sliders are prohibited along enfronting facades.
- Window panes shall be recessed a minimum of three inches and a maximum of eight inches from the adjacent facade, except on frame houses, on which panes shall be recessed a minimum of two inches.

- Where windows lights are utilized they shall be true divided lights, simulated divided lights, or one-over-one lights. Grids-between-glass (GBGs) are prohibited.
- Window trim shall not be flush with the exterior facade and shall provide a minimum relief of one-quarter inch or greater.
- Where used, window shutters shall match one-half the width of the window opening.
- O Painted window or door glass is prohibited.
- Enfronting windows and door glass (except on churches and fire stations) shall utilize clear glass or tinted glass. Tinted glass shall have a transmittance factor of 50 percent or greater and shall have a visible light reflectance factor of ten or less.
- Windows shall be provided for a minimum of thirty (30) percent and a maximum of 50 percent of the total street-facing facade of the principal building, with each facade and story calculated independently.
- Street-facing window units shall not exceed 28 square feet with minimum height of three feet, with the exception of transoms and fan lights.
- Wood trim between four and six inches wide shall surround windows of wood frame structures. Windows grouped together shall have center mullions two inches wider than the side trim.
- Sills shall be of masonry, wood, stone, cast stone, or terra cotta.

- (h) Detached one-family dwellings/ two-family dwellings. In addition to the requirements of subsections (a) through (g), the following shall apply to detached one-family dwellings and two-family dwellings.
- First Stories. First stories shall be elevated above the grade between two and four feet, unless existing topography is greater or unless wheelchair access is desired and cannot be provided from the side or rear.
- Window Sills. Enfronting first story window sills should be no less than two and one-half feet and no more than three and one-half feet above finished floor elevation.
- Wheelchair access. Where practical, wheelchair access, when provided, should be installed at the side or rear of the home in order to preserve the architectural character of the primary facade.
- Architectural style. Architecture is one of the most critical components of place, and nowhere is this more evident than on building facades. The design and character of street-facing facades is a reflection of both buildings and their users, and must be carefully considered for its impact on the overall sense of place.

Other:

New homes in the neighborhood conservation area should be designed to reflect the principal traditional styles found in the community. These include national folk, Queen Anne, ranch, Tudor revival, craftsman, and minimal traditional styles.

These styles, however, do not reflect the only styles historically found in Hapeville, which also includes a few occurrences of neocolonial revival. Where an applicant desires to utilize a style historically found in Hapeville, but not reflected in the six principal styles identified in subsections (4)a. through (4)e., they shall provide the Design Review Committee with photo documentation of the relevant style in Hapeville, a description of the key features of such style, and written justification of such style's appropriateness for the community.

- The plans should ensure windowsills are between 2.5' and 3.5' above finished floor elevation.
- The architectural style of the proposed dwelling does not conform to one of the six recognized traditional styles found in Hapeville.
- Outbuildings. In conventional development, outbuildings are often designed and located as an afterthought. Yet in traditional towns and cities, outbuildings serve to enrich the quality of design through their placement, design and use. In Hapeville, where outbuildings are provided on many residential lots, their design must be to the same high standards found in the community's neighborhoods.

The following standards shall apply to construction of new outbuildings in residential districts.

- i. On lots with one street frontage, set outbuildings back at least 15 feet behind the front facade of the principal building.
- ii. On corner lots, outbuildings should be setback at least 15 feet behind the front facade of the principal building and with a setback greater than or equal to that of the facade along the side lot line.
- iii. Outbuilding may be linked to the principal building with covered walks, trellises or enclosed breezeway.
- iv. Outbuildings shall be of compatible material and architectural style to the principal building.
- v. Outbuildings shall have a minimum height of 14 feet and a maximum height of that of the principal building or 25 feet, whichever is less.
- vi. Outbuildings shall be set a minimum of ten feet from any other outbuilding on adjoining lots.

STAFF COMMENT:

RECOMMENDATIONS

The proposed design does not reflect any of the traditional styles found in Hapeville. In addition, the submitted plans do not ensure windowsills are between 2.5' and 3.5' above the finished first floor elevation.

Once these items are addressed to the satisfaction of Staff and/or the Design Review Committee, the application can be approved.

CITY OF HAPEVILLE DESIGN REVIEW APPLICATION

The second secon	
SUBMITTAL	DATE: 6-19-19
NOTE:	All applications must be typed or neatly printed. Applications or an authorized representative is required to personally appear at the Design Review Meeting to answer questions.
	The Design Review Committee meets the third Wednesday of each month. Every attempt will be made to place your application for review on the next month's agenda following the submittal of a completed application with supporting documents; however, that may not always be possible. The City reserves the right to schedule applications as deemed necessary.
Applicant:	Jimmy L JOYNEY Contact Number:
Applicants Ac	ldress:
E-Mail Addres	zoning Classification:
Address of Pr	roposed Work: 105 LYLLY Street Hapeville Ga. 303.
	FORMATION MUST BE PROVIDED):
Property Own	er: William Garcia Contact Number:
Project Desc	Singly Fam.ly Vesidential
Contractors	Name: Contact Number:
Contact Pers	son: Contact Number:
property. I do accurate, and application and reserves that rill further under full. I hereby a write the Englivoluntarily con the City of Hap	application to the City of Hapeville, to the Design Review Committee for the above referenced hereby swear or affirm that the information provided here and above is true, complete and I understand that any Inaccuracies may be considered just cause for invalidation of this d any action taken on this application. I understand that the City of Hapeville, Georgia, ight to enforce any and all ordinances regardless of any action or approval on this application. I stand that it is my/our responsibility to conform with all of City of Hapeville's Ordinances in acknowledge that all requirements of the City of Hapeville shall be adhered to. I can read and ish language and/or this document has been read and explained to me and I have full and application. I understand that it is a felony to make false statements or writings to eville, Georgia pursuant to O.C.G.A. 16-10-20 and I may be prosecuted for violation thereof.

Project Class (check Residential	•	
Residential	Commercial	Mixed-Use Development
Project Type:		
New Commercial	Construction _	Addition to Existing Commercial Buildin
Addition to Existin	g Residential Structure _	Accessory Structure
Site Plan, Gradine	g & LandscapingN	ew Single Family Residential Construction
Other		
Total Square Footage of	proposed New Construction:	1990
	existing building:	
Estimated Cost of Constr	uction: 150,000	
List/Describe Building Ma	terials proposed for the ext	erior facade of the new structure:
Ha	rdy Plank	SIDING

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(Please Print & Initial)

I Jumy L Joyner swear or affirm that before receipt of an application, I have received this notice and I read and write the English language or I have had someone read and explain this document to me.



DEPARTMENT OF PLANNING AND ZONING

DESIGN REVIEW APPLICATION INSTRUCTIONS AND ACKNOWLEDGEMENT

, the undersigned, agree that with my signature and submission to the City of Hapeville, I have done th following:	е
Read the City of Hapeville's Architectural Design Guidelines and relevant Code sections for my proposed project. The Architectural Design Guidelines may be found here: https://library.municode.com/ga/hapeville/codes/code of ordinances?nodeId=PTIICOOR CH81ARDES	Ţ
Ensured that my proposed project meets all of the required criteria per the City of Hapeville Code of Ordinances.	
Submitted my application materials in full by the published deadline for review by Staff prior to the Design Review Committee meeting.	e
Identified and explained all deficiencies or components of the proposed project that do not meet with the requirements set forth in the Code. This explanation should be submitted as a separate document in the application.	
Understood that any deficiencies in the application must be resolved at least 10 days prior to the Design Review Committee meeting or the application may not be presented to the DRC for review	, 1
Submitted architectural drawings and details for all projects unless allowed in writing by the Community Services or Planning & Zoning Department.	
Agreed to submit any required revisions by the Design Review Committee with updated drawings to the Community Services Department for review prior to requesting any permits.	
Jumy 6 Janvel 6-18-19	
Printed Name Signature Date	_

Should you have any questions, please do not hesitate to contact the Community Services Department at 404-669-2120.

Thank you for interest and investment in the City of Hapeville.



SHEET & LOCATION PLAN

FABLE OF CONTENTS

COVER

AC - RENDERED VIEW

A1 - COVER SHEET, LDCATION PLAN & VICINITY MAP

AS - EXTERIOR FRONT & REAR ELEVATIONS A6 - EXTERIOR LEFT & RIGHT ELEVATIONS

A4 - FIRST & SECOND FLOOR PLANS

A3 - FOUNDATION PLAN & DETAILS

A2 - FLOOR FRAMING P_AN

-DR INFORMATION CONTACT:

3515 ZIP INDUSTRIAL BLVD HAPLVILLE, GA 30354 404-886-4857 ENGINEER: WILLIAM CARCIA

8 VICINITY MAP COVER SHEET

105 LILLY STREET HAPLYILLE, GA 30354

REVIS:0NS:	CATE			
	No.	 2	~	

_	_		
	ARED BY:	ZLH Z	06-26-18
m	PREPARED		DATE:

SCALE: AS NOTED

SHEET No.

VICINITY/CONCEPTUAL MAP SCALE: NONE

MECHANICAL FEATURES PREFERRED LOCATION

NDTES

WICHANICAL FFATURES SHALL BF SCRFENED FROM VITW
FROM ANY PARK OF ALONG ANY PUBLIC RIGHT-OF-WAY
WITH PLANTING, WALS OR FENCES OF EQJAL OR
GRAFIER HEIGHT, ACCEPTABLE NOW-VEGETATIVE
WATERIALS FOR SCREENING SHALL INCLUDE PAINTED
WOOD OR THOSE FOUND IN SECTION 95-2-3. SAD
FEATURES ARE ENCOURAGED NIT TO BE LOCATED IN THE
SUPPLEMENTAL AREA.

UDT COVERAGE BLDG 1667 SF

DRIVEWAY 950 SF WALKWAYS 114 SF STAIRS 39 SF

PORCH 275 SF TOTAL COVERAGE 3045 SF PARCEL AREA 7799 SF TDTAL COVERAGE 39.0%

MO3∘2014.E 88138. SP10.58 W A KW KY PORCH N8/°5/01"W 78.09" 78.25 S87°26'40"E

LILLY STREET

PROPISED SIDEWAL

PROPERTY CLASSIFICATION: R3-RESDENTIAL (IBC)

HARDIPLANK SIDING, BRICK FRONT

DESIGNER:

SINCLE FAMILY CONSTRUCTION

HAPEVILLE, GA 30354 PROJECT ADDRESS:

BEDROOMS, 3 1/2 BATH PROJECT DESCRIPTION:

LIVING AREA SECOND FLOOR 1068 SF

TCTAL LIVING AREA 1990 SF GARAGE AREA 442 SF

BULDING HEIGHT 32'-5" LCT AREA 7799 SF (0.18 AC) PARCEL ID 14009900040421

LIVING AREA FIRST FLOOR 922 SF

ZCNING: R1

LOCATION PLAN

APPLICABLE CODES:
INTERNATIONAL BUILDING CODE, 2012 EDITION, WITH GEORGIA AMENDMENTS
INTERNATIONAL RESIDENTIAL CUDE, 2012 EDITION, WITH GEORGIA AMENDMENTS
INTERNATIONAL MECHANICAL CODE, 2012 EDITION, WITH SERVICAL AMENDMENTS
INTERNATIONAL POLICAGE, 2012 EDITION, WITH GEORGIA AMENDMENTS
INTERNATIONAL FORE CAS CODE, 2012 EDITION, WITH GEORGIA AMENDMENTS
INTERNATIONAL FORE CODE, 2012 EDITION, WITH GEORGIA AMENDMENTS
INTERNATIONAL FIRE CODE, 2012 EDITION, WITH GEORGIA AMENDMENTS
AMENDMENTS
AMENDMENTS
NER RATIONAL ENERGY CONSERVATION CODE, 2009 EDITION, WITH GEORGIA SUPPLEMENTS AND
AMENDMENTS

2012 NFPA 101 LIFE SAFETY CODE WITH ALL GEORGIA STATE AMENDMENTS


PROJECT NAME: NEW 2-STOREY SINGLE FAMILY RESIDENCE


A12 - LANDSCAPE PLAN PROPOSED


A11 - LANDSCAPE PLAN EXISTING A1) - NOTES & SPECIFICATIONS


AE - DOOR & WINDOW SCHEDULE AS - ROOF PLAN


A7 - RODF FRAMING PLAN

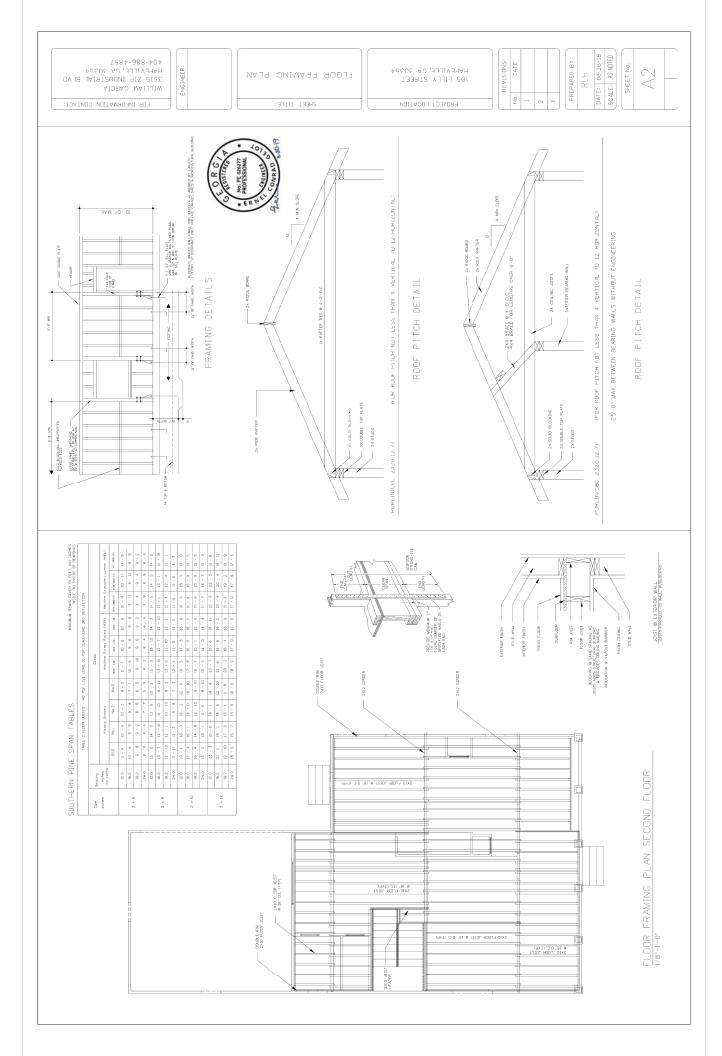


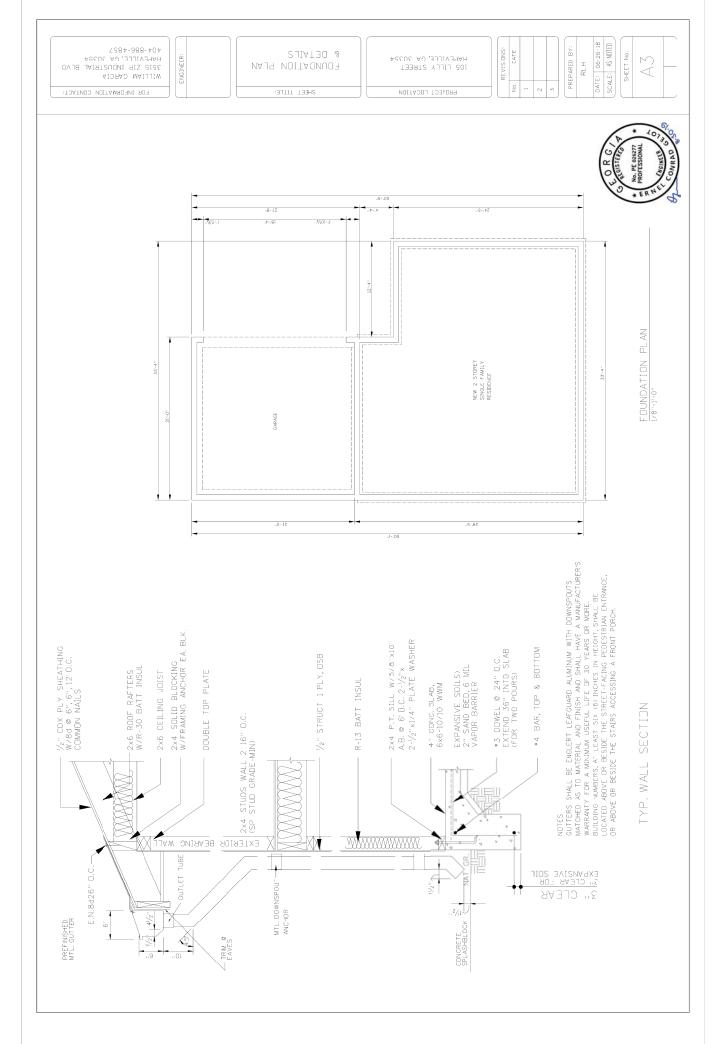


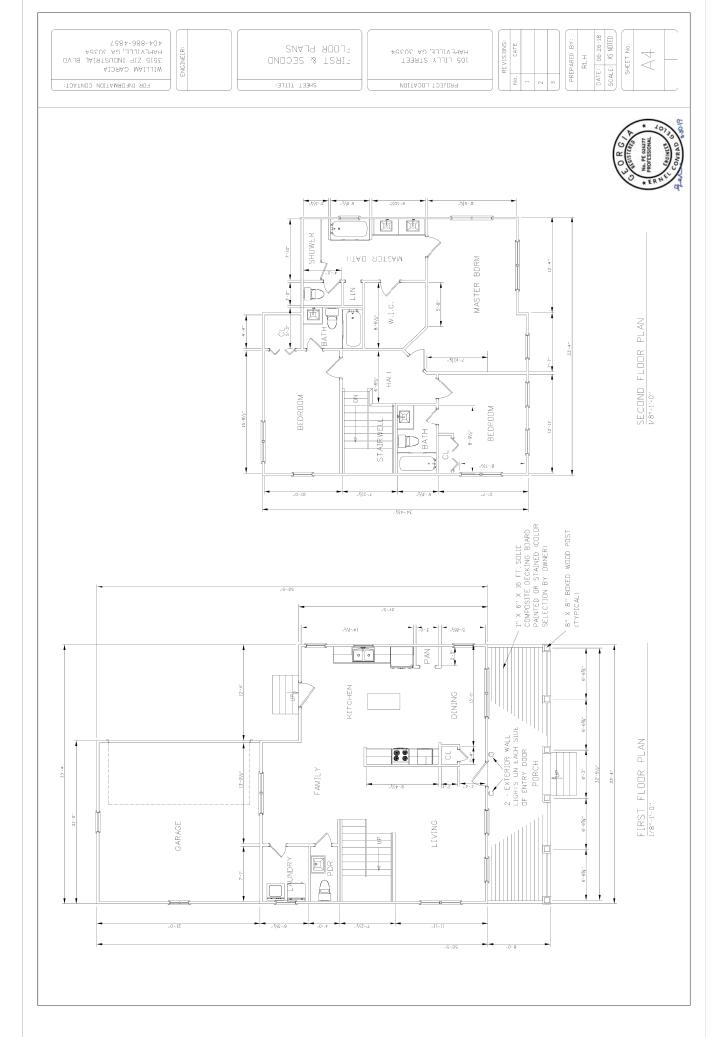

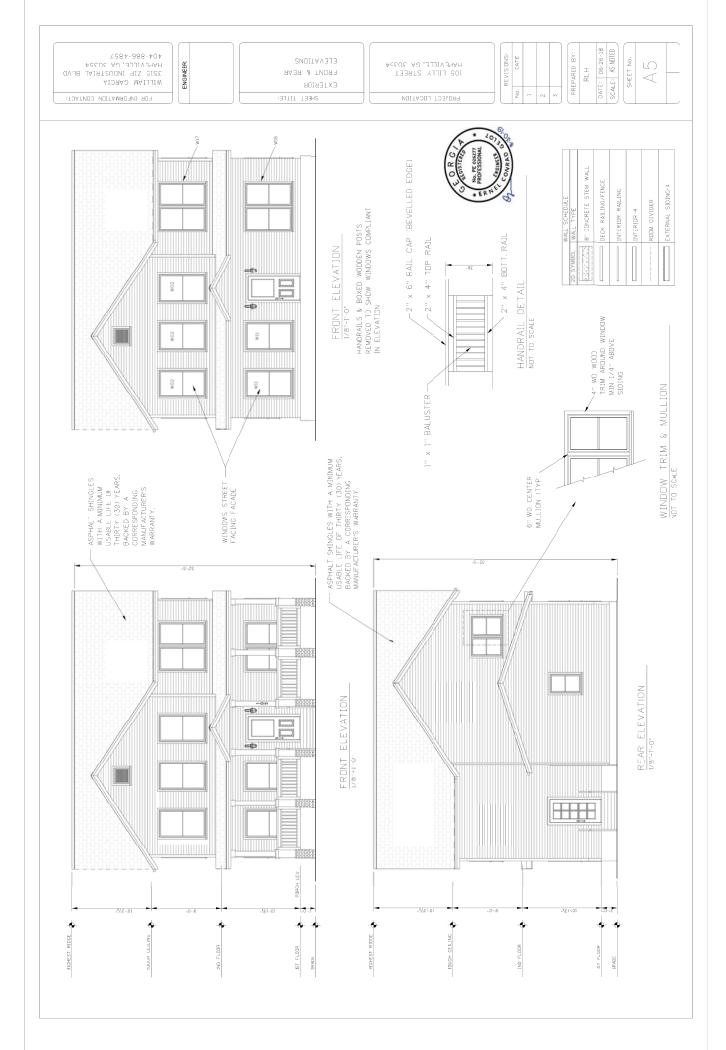


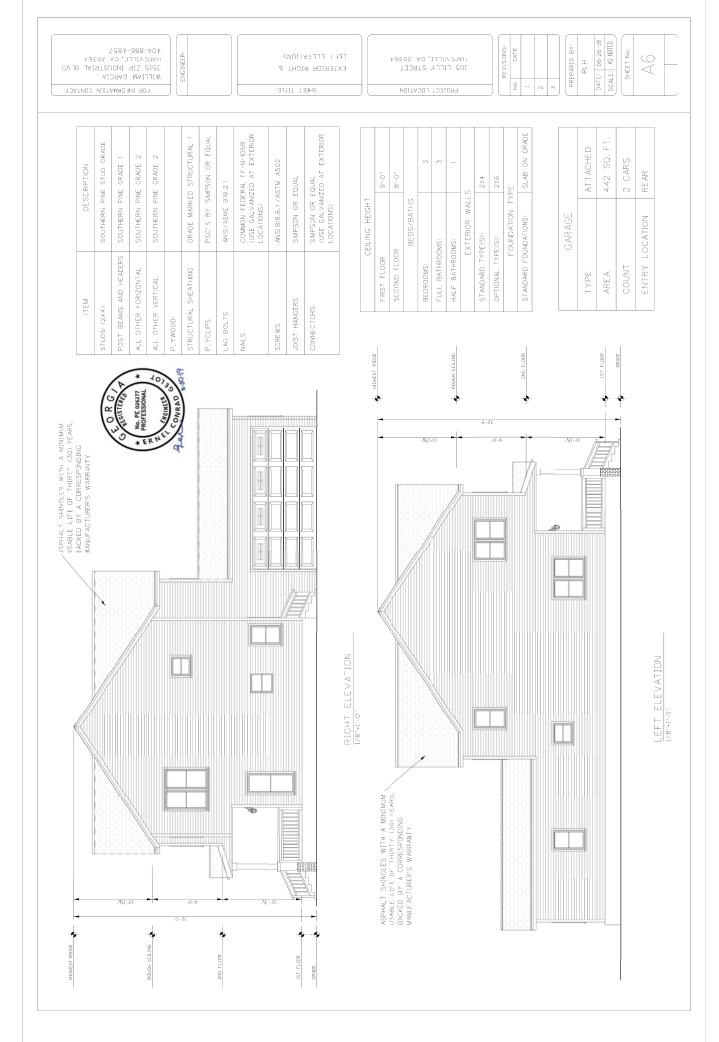

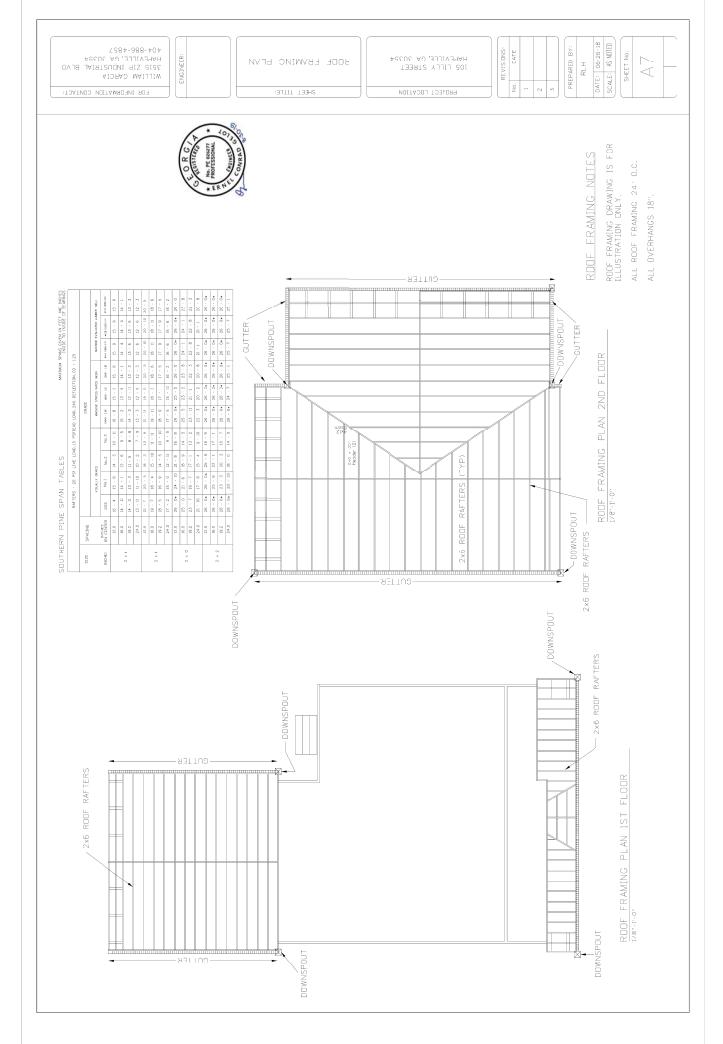

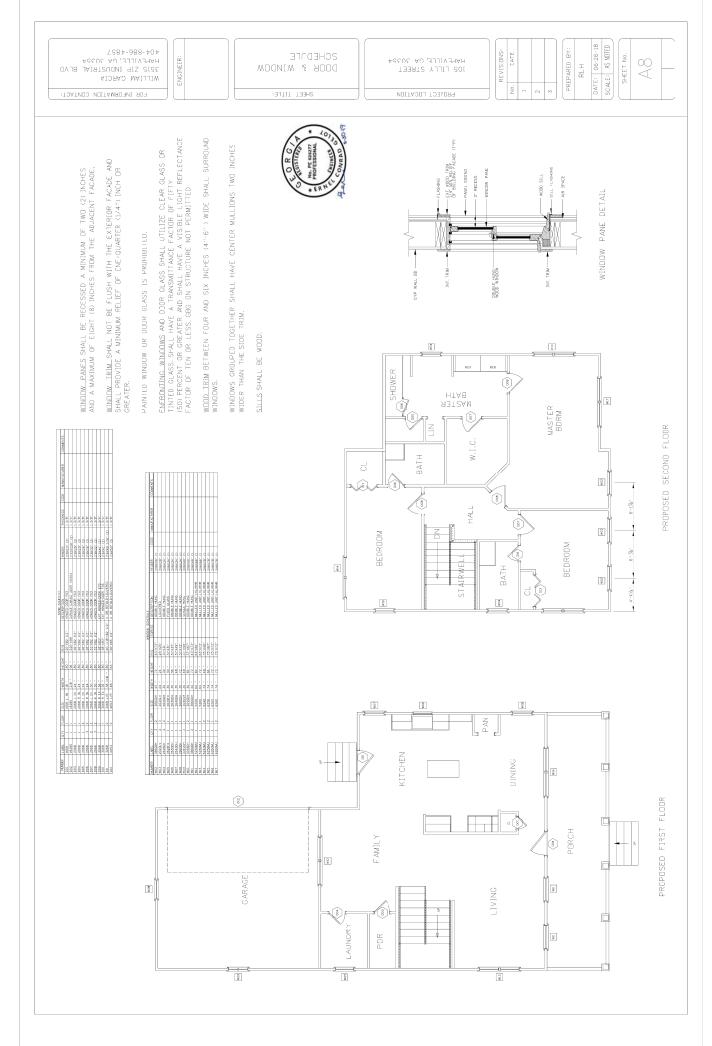

PREPARED BY:
RLH
DATE: 06-26-18
SCALE: AS NOTED WILLIAM GARCIA 3515 ZIP INDUSTRIAL BLVD HAPLVILLE, GA 30354 404-886-4857 REVIS:ONS: SHEET No. 105 LILLY STREET HAPEVILLE, GA 30354 8 ENGINEER: BOOF PLAN PROJECT LOCATION FOR INFORMATION CONTACT: SHEET TITLE: 8:12 <8:12 8:12 ROOF PLAN 2ND FL 1/8"=1"-3" DETAILS 8:12> ROOF PITCH 8:12 8:12 PRIMARY NOTES
BULLOUS ROOF SHALL BE OF
ASPHALT SHINGLES WITH A
MINIMUM USABLE LIFE OF
THRIY (30) YEARS, BACKEE
BY A CORRESPONDING
MANUFACTURER'S WARRANTY. BUILDING DUTLINE ____<u>3:12</u>

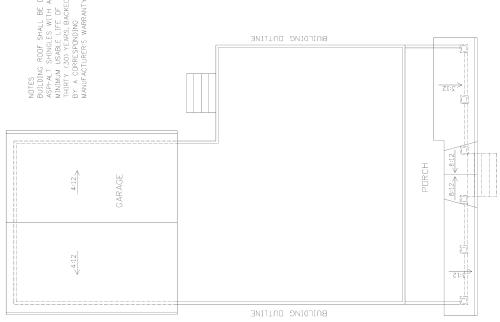

ROOF PLAN 1ST FL 1/8"=1'-0"

NOTES AND SPECIFICATIONS

PROJECT SUMMARY: THIS PROJECT IS TO CONSTRUCTZERECT A NEW SINGE FAMILY HOUSE

.OCATION: IOS LILLY STREET, HAPEVILLE, GA 30354

CEMEDA WORK PERFORMED BY THE CONTRACTOR SHALL CONFIDENT TO THE RECOURSENTS OF TANDER LOOPE, DOWN ON FEDERAL AND STATE LAWS NG WILLIA OF ANY OTHER DOVERNING RECOURSEMENTS, WHETHER DR NOT

WHERE TH CONTRACT MOTES OF DAMPINGS CAL THE ANY WIRN OF A MOTES STRACENT WANTER RECOVERD IN THE UNLINK ONDS CAME ANY OTHER DEPARTMENT HANNE UNISSOFTIAN OFFER THE WORK. HE WISH OFFER THE WORK THE CONTRACT.

THE CONTRACTOR SHALL DBFAIN AND PAY FOR ALL LEGALLY REQUIRED APPROVALS AND PERMITS NECESSARY FOR THE EXECUTION AND COMPLETION OF HIS WERK, FORWARD CIPPLES OF EXECUTED PERMITS TO DINNER.

4L PRAINGS AND ALL CONSTRUCTION NOTES HE COMPLEMENTARY, AND WHITE SALLED FOR BY TITLER WILL BE BROOK AS I CALLED PIRE BY ALL, ANY WIRNS SHOWN BY REFERED ID BY ANY DAYS SHALL BE PROVIDED AS THOUGH SHOWN DN ALL RELATED FRAMINGS.

THE CONTRACTOR IS WHOLLY RESPONSIBLE FOR THE COURDINATION SCHELOLING OF THE WORK OF ALL SUBCONTRACTORS CRAFTSMEN RRADESMEY REQUIRED TO COMPLETE THE JOB.

CONTRACTOR SHALL NOTFY DWARE NAMEDATELY OF ANY REPACLES OR DUSSIONS BETWEEN THE DRAWINGS, THESE NOTES PREFETCHIONS, AND FIELD COMDITIONS, AND REQUEST CLAMPLICATION RE COMMENCING ANY WIERS. THE CONTRACTOR SHALL NOTFY DWNER IMMEDIATELY IF HE CANNOT SOMPLY WITH ALL REQUIREMENTS CALLED FOR ON THESE DRAWINGS.

CONTRACTIR SHALL CHECK AND VERFY ALL DIMENSIONS AND CINDUITINS AT JUST STEEL TREALTHON TO THE WINNE OF ALL THROUGHS AND ALLOWING SHALL BE WADE TER ANY EXTRA EXPENSE OR STEENSION OF TIME DUE TO CONTRACTOR'S FAILURE OR NEGLIGENCE IN CONFLETELY EXAMINING THE JUSTSHIFT.

THE CONTRACTOR SHALL DEFEND AND HOLD HARMLESS THE ENGINEER, THE TOWNER AND DOWNERS, ABOUNTS AND REPRESENTATINES FROM MAY LEGAL, ACTION SHOULTING FROM HAY UNDER CONDUCT OF THE WORK.

THE CONTRACTOR SHALL CLEAN THE WORK AND PREMISES PRIDR TO ACCEPTANCE BY DWNER.

CONTRACTOR SHALL SUBMIT SAMPLES OF EXTERIOR AND INTERIOR MATERIALS INCLUDIOND DOOR HARDWARE AND FINISHES TO THE OWNER FOR APPROVAL TO "NSTALATION." CONTRACTOR SHALL DETAIN ALL REDUIRE) PERMITS INCLUDING MECHANICAL, CLECTRICK, WID FLUMDING WORN AS MECESSART, INC CONTINUED SINCL FURNISH AND INSTALL ALL PARTITIONS INDICATED ON THE SRAWINGS. PARTITIONS SHOWN ALIGNED WITH EXISTING BASE BUILDING ELEMENTS SHAL SE INSTALLED FLUSH AND SMOOTH WITH BASE BUILDING ELEMENTS.

CONTRACTOR SHALL BEING ANY DISCREPANCIES TO THE DWNERS ATTENTION RECOLUTING ALONG WITH ANY AND ALONG WITH ANY AND THE REDUCTION DETAILS IF APPLICABLE.

COSTS DULTO DEFECTIVE AND/OR ILL-TIMED WORK AS A RESULT DF, BULT NOT IMPROPER SCHEDULING OR DELINQUENT ORDERING SHALL BE BORNE BY CONTRACTOR.

DOMPSTERS OR ANY DIVSITE DISPUSAL EQUIPMENT MAY NOT BE LUCATED ON THE SIREET.

THE CONTRACTOR SHALL REMOVE ALL RUBBISH WND WASTE MATERIALS FROM HIS AND HIS SUBCONTRACTORS WORK AND DISPOSE OF THESE AT APPROPRIATE WASTE MANAGEMENT FACILITIES AT HIS COST.

CONTRACTOR SHALL EXERCISE STRICT DUST CONTAINMENT AND 'CON'ROL TO PREVENT 3IRT OR DUST FROM LEAVING THE JUBSITE TO MNIMIZE CONTAMINATION OF DUCTS AND AIR HANDLING EQUIPMENT SHOULD THE CONTRACTOR DAMAGE ANY NEW DR EXISTING CONSTRUCTION. STRUCTURE, DR EQUIPMENT HE SHALL REPAIR OR REPLACE THESE AT HIS COST TO THE SATISFACTION OF AND AT NO COST TO THE OWNER.

CONTRACTOR SHALL REPAIR, REPLACE OR MODIFY ANY FIXTURE, STRUCTURE, OLDSWALL, CELLURE, COUPMAN, I.C. DING, CHOUNTON, END OF THAT REQUIRES TEMPORARY CONSENCTION, IN PACTAMATION IN OMORE TO ACCOMMODATE, THE NEW CONSTRUCTION.

THE CONTRACTOR SHALL PROVIDE ALL NECESSARY PROTECTION FIR HIS MORK AND THE PREMISES UNTIL COMPLETION OF CONTRACTED WORK.

KAWINGS, NUTES, AND SPECIFICATIONS CONVEX THE DESIGN THE CONTRACTOR SHALL USE THE HIGHEST POSSIBLE QUALITY OF SIP, NEW MATERIAL, AND EQUIPMENT IN PERFORMING THE WORK. CONTRACTOR SHALL MANTAIN A CURRENT AND COMPLETE SET DF STRUCTON PLANS ON SITE FOR USE OF ALL HIS SUBCONTRACTORS AN RESMEY AND SHALL BE RESPONSIBLE FOR COORDINATING THEIR WORK.

THE CONTRACTOR SHALL CODPERATE WITH THE DWINER IN SCHEDULING WAND RESILIUMS SCHEDULE AND CHIPMETEDS WITH OTHER CONTRACTORS OF THE OWNER TO PERFORM OTHER WORK AT THE SITE.

DODR HANDLES, PULLS, LATCHES, LOCKS AND OTHER DPERATIVG DEVICES SHALL SINGLES SHALL SINGLES MANDAWA AND US INCHES MANDAMA AND VEIT PRINSHED FLODR LIDCKE USED DALY FOR SECURITY BURPOSES AND NOT USED FOR NORMAL DPERATION ARE PERMITTED AT ANY HEIGHT.) DODR CLOSERS AND STOPS SHALL NOT REDUCE HEADROOM "O LESS THAN 78 INCHES.

NTERIOR WALL AND CEILING FINISHES CLASSIFIED IN ACCORDANCE WITH MALL BE AS FOLLOWS: VTESTING IN ACCORDANCE WITH ASIM E-84 OR

DURING CONSTRUCTION CONTRACTOR SHALL PROVIDE NOT LESS THAN ONE UPER ARE FIRE EXTINGUISHEN KAILD AT LEAST 2"A AT EAUH STAUWAY UNALL TUOR LEVELS WHERE CONBUSTIBLE MATERIALS HAVE ACCAMULATED.

ACCESSIBILITY / SAFETY
SUNRANCIOR SHALL FROVIDE ANY AND ALL LIFE SAFETY EQUIPMENT AS
EQUIRED BY LIGGAL AND STATE CODES.

LIGHT AND CONTROL SWITCHES SHALL BE MOUNTED NOT MORE THAN 4'-0" ABOVE THE FLOOR OR WORKING PLATFORM.

THE CONTRACTOR SHALL AS MEDED ADJUST OR REFURBLISH EXISTING MANNEAVER DEBAS OF DEBAS OF THE REMOVED ANT TIGHTEN ANY LODGE TIENS SUCH AS EXIT STONS, ALANNE FIRE EXTINGUISHER CASES, SPEWERS, MOLDINGS AND DODR HARDWARE.

CONTRACTOR SHALL ACQUIRE INSURANCE AND BONDING AS DIRECTED TO THE SATISFACTION OF THE OWNER AND PROVIDE PROOF OF SUCH TO THE OWNER.

CONTRACTOR SHALL VEREY SIZE, LOCATION, ELECTRICAL REQUIREMENTS CHARACTERISTICS OF ALL WORK ANA/OR EQUIPMENT SUPPLIED BY THE REQUIRES PRIGN TO THE START OF RELATED WORK WITH THE PRACTICKE ON SUPPLIES.

ALL PENETRATIONS OF THE BUILDING ENVELOPE SHALL BE SEALED WITH CAULK DIR FORM.

ALL EXHAUST FANS TO BE VENTED DIRECTLY TO THE EXTERIOR. "LAME SPREAD INDEX NOT GREATER THAN 200. SMCKE-DEVELOPED INDEX NOT GREATER "HAN 450.

AL COMBUSTION APPLIANCES WILL BE VENTED DIRECTLY TO THE EXTERIOR. FURBAGE FIREBOX SHALL HAVE DUTSIDE COMBUSTION AIR SUPPLY PURSUANT TO REGIONAL AND LOCAL CODES. CYPSUM BOARD THICKNESS AND APPLICATION SHALL CONFORM TO IRC TABLE 702.3.5 ALL FRAMING LUMBER SHALL BE SOUTHERN PINE GRADE 2 OR BETTER UNLESS MOTED OTHERWISE.

OWNER MAY DROER EXTRA WORK WITHOUT INVALIDATING THE CONTRACT CONTRACTOR SHALL BE PAID EXTRA FOR SUCH WORK AT NEGSTIATED SES AND AGREED UPON EXTRA TIME TO CONPLETE IF NEGESSARY. CONTRACTOR IS RESPONSIBLE FOR PAYING ALL DELIVERY TO SITE AND ADJING CHARGES FOR ALL MATERIAL AND EQUIPMENT NECESSARY FOR A DIT OF INCORPORATED INTO THE WORK. TIME IS OF THE ESSENCE IN THE CONTRACT AND CONTRACTOR SHALL SUBMIT A DETAILES SCHEDULE OF WORK THROUGH COMPLETION. XXCEPT WHERE DTHERWISE INDICATED, DIMENSIONS ARE FROM FACE OF FINISH TO FACE OF FINISH.

ATTE ACCESS SHALL BE:
A MINIMO OF 22' X OF THER SHALL IE 30" WIN CLEARANCE AT DR
A MINIMO OF TAX X OF THER SHALL IE 30" WIN CLEARANCE AT DR
ACCESSIBLE CLEATURATION OF ANXINGWA VERTICAL "ETGHT OF LESS
THAN 30" WILL WIT REQUIRE ACCESS DERINGS.

ALL MATERIALS AND WORKMANSHIP SHALL BE GUARANTEED FOR A PERIOD OF SINE YEAR AFTER SUBSTANTIAL COMPLETION OF WORK.

IN SOUND RATED RODAS, ALL WALL AND FLOOR PENETRATIONS FOR PIPES, DUCTS. AND OUTLETS SHALL BE SEALED WITH AN ACCUSTION, SEALMAT AND CONSEASED ON RECESSED STANCES SHALL BE COVERED ON BACKED WITH A SOUND ATTENATION BACKED WITH A SOUND ATTENATION BACKED WITH A SOUND ATTENATION BACKED. HE CONTRACTOR SHALL PROVIDE BLOCKING, BACKING, FRAMING HANGERS, OR DITHER SUPPORT FOR ALL FIXTURES, EQUIPMENT, CABINETRY, FURNISHINGS, AND ALL OTHER JTEMS AS REQUIRED.

ATTE SALL HANG VEHTLATION BOUN. "O I SQUARE FROT PER 150 SO, ATTE SALL HANG VEHTLATION BOUN." O I SQUARE FROT CITD FROM SAND WHE ANAL BE CORRECT ON WHI CALANZED WHE SCHELL DEBUNGS SALL BE LOCATED TO FROM ES GOOD SALL ATT LIDDR SPACES SHALL HAVE VENTLATION EQUAL TO DNE SQ. FDDT 1 SQ. FEET AND SHALL HAVE NEW THAT THE PROPERTY OF TH

BLOOMS: MID SUMMER - EARLY FALL

20NE: 4-9

NANT HEIGHT: 6 FT - 7 FT

PLANT WIDTH: 4 FT - 5 FT

RALING NOTES: STARWAYS SHALL HAVE A MIN, WIDTH OF 34", HAND RAILS MAY ENCROACH A M.K. DF 3" INTO THE REQUIRED WIDTH. TREADS SHALL HAVE A MIN, WIDTH OF 9", STAIR TREADS MIST BE UNIFORM AND CAN NOT VARY FROM THE LARGEST TO THE SMALLEST BY MORE THAN \$7.481.

FER TOD SULFIEL.

BIF FLOOR SPACE, VENTS SHALL BE CAST INTO THE CONCRETE STEM WALLS
WAND COVERED WITH CALVANIZED WIRE SCREEN, VENTS SHAL. BE LOCATED
TO FROVIDE CROSS, VENTLATION.

STARWAYS SHALL HAVE MIN.6'-8" OF HEADROOM AT THE NOSE OF THE STAR.

ENCLOSEO USABLE SPACE UNDER INTERIOR STAIRS SHALL BE PROTECTED ON THENCLOSED FACE WITH "TYPE" X" FIRE-RESISTANCE RATED GYPSUM WALL 80APO.

CONTRACTOR SHALL SECURE THE BUILDING AT THE CLOSE OF WORK EACH DAM

BY SNIERING INTO AN AGREEMENT WITH THE DWNER, THE CONTRACTOR REPRESENSY THAT HE AS VISITED THE JOB SITE, FAMILIARIZED HIMSELF WITH EXISTING CONDITIONS AND INTED ANY DISCREPANCES WITH THE CONTRACT DRAWINGS. AND DITHER DUCUMBUTS.

CONTRACTOR SHALL SWEEP FLOOR AREA IN ADVANCE OF FLOOR OR WINDOW TOTOPTRING OR CABINET INSTALLATION EVEN IF THESE ARE TO BE DONE BY TOTOPTRING OR CABINET INSTALLATION EVEN IF THESE ARE TO BE DONE BY

HE CONTRACTOR SHALL VERIFY REQUIRED LOCATION OF ALL NECESSARY ACCESS PAMELS ON PARTITIONS, FLOORS, OR CELLINGS AND CODROINATE EXACT. DCATIONS WITH DWINER BEFORE INSTALLATION.

CDNTRACTOR SHALL ENSURE THAT INSTALLATION METHOOS CONFORM TO ALL APPLICABLE BUILDING CODES.

ALL ITEMS ARE NEW UNLESS NOTED OTHERWISE.

DODR DPENINGS IN GYPSUM BOARD PARTITIONS NOT DIMENSIONED ARE LOCATED IN CENTER OF ROOM OR WITHIN 4" OF ADJUSTING PARTITION.

STARWAYS SHALL HANE AT LEAST DNE HANDRAIL LOCATED 34" TO 38" PARCH THE MISTOR OF TREGAS AND LANCINGS. THE HAND RIP PORTION OF HANDRAILS SHALL NIT BE LESS THAN 1-YZ" OR GREATER PLAN 2" IN CROSS-SECTIONAL DIMENSION.

34" MIN. HEIGHT GUARRAILS SHALL BE FROVIDED FOR ALL PORCHES, DECKS, DECKS, SHAWAYS AND LANDINGS WERE THE ADJACEN. SURFACE IS SHETTER THAN 24" BEIDW. RALLS SHALL BE CONTINUOUS THE FALL LENGTH OF THE STAIRS. THE OF HANDSALLS SHALL RETURN TO WALL OR TERMINATE INTO A NEWEL OR SAFETY TERRINAL. STARWAYS HAVING LESS THAN 2 RISERS DO NOT REQUIRE A HAND RAIL.

RAILING AND GUARDRAL BALUSTER SPACING SHALL BE NOT GREATER THAN 4 %. THE TRIANGULAR DPENNGS FORMED BY "HE RISER, TREAD, IND BOTTOM OF GUAPDRAIL SHALL NOT ALLOW A 6" DIAMITER SPHERE TO FASS THROUGH.

SPECIFICATIONS NOTES &

SHEET TITLE:

105 LILLY STREET 405 AU JULLE, GA 303

REVIS:0NS:	CATE		
	o'N	 2	2

PREPARED BY:

7

DATE: 06-26-18 SCALE: AS NOTED

SHEET No. AIO

ANDINGSCAPING NDTES

HYDRANGEA PANICULATA SPECIES: PANICULATA

GENUS: HYDRANGEA

3515 ZIP INDUSTRIAL BLVD HAPLVILLE, GA 30354 404-886-4857

HEROEN IN TLAS ANY OP RETAINING PART IN USUS THE CASE TO A PART ON THE REAL STANDARD AND A PART OF THE REAL STANDARD AND A PART OF THE REAL STANDARD AND A WARREN THE STANDARD AND A LESS IT OF THE PART OF THE STANDARD AND A LESS IT OF THE PART WARREN DESTRUCT WARREN WARREN TO THE PART OF THE PART WARREN DESTRUCT WARREN WARREN TO THE PART OF THE PART OF

ENGINEER:

FOLLOW THIS MAINTENANCE SCHEDULE FOR A FEW SEASONS AT A MINIMUM, DR. LONGER IF SIRESSFUL CONDITIONS, SUCH AS ORDIGHT OCCUR.

PRUME IN LATE WINTER TO KEEP THE PLANTS FROM BECOMING OVERGROWN AND ENCODRAGE WARM KNW GROWN HAVDER FOUNDER BUGS, AND LARGER BLIDES, RRADING ENCODE LOWERS, KS. SIDNA KS. PET'S BECOME UNATIRECTIVE AND CLEAN UP THE UNEXALL SHAPE UP THE PLANT. EASTERN REDBUD

SPECIES: CANADENSIS GENUS: CERCIS

ZONE: 4-9

BLOOMS: EARLY SPRING - LATE SPRING

NANT HEIGHT: 15 FT - 25 FT

REST PARTIZE THE REAR SPRING NA UNISTURGENETIVELY BELL-PRINCE SILL DO A HOLE THAT IS ALL LOST THESE THINS AS VIDE AS THE ROLD BECKNET THE ROLD BEAL IS THINK THE ROLD WITH THE ROLD THE THE THE THAT IS THE THE THE THE THE THE THE THE THAT IS THE ADVANCE THE THE THE THE THE THE THAT IS THE ADVANCE THE THE THAT IS THE TH PLANT WIDTH: 15 FT - 25 FT

10 RETAIN MOSTURE, PLACE ABOUT 3 INCHES OF MULCH AROUND THE TREE DUT TO THE DISP LIKE OF THE LUMSS BUT NOT TOUCHNG THE TRUNK MULCH AFTER PLANTING AND AGAIN EACH SPRING FOR AT LEAST THE FIRST TWI YEARS, PRUNE DIKY TO SHAPE OR TO REMOVE DEJO POWNERS.

KEEP THE SOIL MOIST, BUT NOT SATURATED, WHILE THE TREE IS ESTABLISHING, WATER WITH A DRIP SYSTEM IF PUSSIBLE. IF PLANTED IN FULL SUN, WATER REGULARLY. PRUNE RIGHT AFTER FLOWERING OR IN LATE FALL WHILE THE TREE IS DORMANT

DJRNG THE WANGE NICHTS, PROVIDE DEEP WATERING TO A DEPTH OF 10° TO 12°) ABDJJ TACK A WESS, OWNER OFF, CAT SOMECHS TO CSTACLISH STRONG MODES, WATER IN THE ERRY MENNING, SE FOLIAGE HAS TIME TO DRY, JF A LATE FROST IS PREDICTED, CDICE THE PARTS TO PROJECT FREM.

. AN ALL-PURPOSE SLOW-PELEASE FERTILIZER OR RICH COMPOST INTO THE SOIL AROUND TREE AT THE ECONNING OF EVERY SEASON. SUGGEST FOREST PANSY LAPPALACHIAN RED VARIETY

GRODIO WILL BE PRIMARLY FOR LEALING BETDE CONCRETE FOURING FIR BUILDING, LONGWARM AND THE BETCHE BUILDING MANY FROM HOUSE WHILL PROPERTIES AND THE PROPERTIES WAS THE TOWN HOUSE WHILL PROPERTIES STRUCTURES, BANKFARM HOUSE GROSIEL FOR BUILDING TO THE TOWN HOUSE OF THE STRUCTURES AND THE TOWN HOUSE THE STRUCTURE AND THE TOWN HOUSE THE STRUCTURE AND THE STRUCTURES.

CONCRETE NOTES

.ALL BACKFILL AND SOIL BELOW SLABS AND FOOTINGS MUST BE COMPACTED TO 2000 PSF MIN 2.FOUNDATION CONTRACTOR IS TO PROVIDE 1/2" v. 10" ANCHOR BOLTS AT 72" OC. AND 12" FERM CORNERS AT ALL PERINETER FOUNDATION WALLS AND ALL BERRING WALLS

3. CONTRACTOR RESPONSIBLE FOR ALL REINFORCEMENT IN CONCRETE WALLS AND BELOW SLAB WHERE REQUIRED ALL REINFORCEMENT IS O MEET LOCAL, COSES, AND MAY REQUIRE INSPECTION BY BUILDNG DEPARTMENT OFFICIALS. 4. ALL CONCRETE TO BE 3000 PSICOMPRESSIVE STRENGTH WITH 4" MAX

STEFL REMEDRACKENT
WALS UNDER 4"0"
* REBAR HORIZ, AT 24"0/C
* REBAR HORIZ, AT 24"0/C
* REBAR HORIZ, AT 24"0/C
* REBAR VERT, & HORIZ, AT 8F'0/C
* REBAR VERT, & HORIZ, AT 8F'0/C
* REBAR CONTINUOUS

CONRAD PROFESSIONAL SHOINEES

DATE: 06-26-18 SCALE: AS NOTED REVISIONS: PREPARED BY: SHEET No. 105 LILLY STREET HAPEVILLE, GA 30354 A117 PROJECT LOCATION


EXISTING SITE

SHEET TITLE:

ENGINETR:

3515 ZIP INDUSTRIAL BLVD HAPEVILLE, GA 30354 404-886-4857 WILLIAM CARCIA FOR INFORMATION CONTACT:



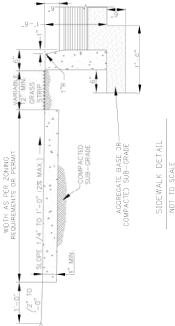

NOTES
SIDEWALK SHALL BE SCRIBED WITH TRANSVERSE CONTROL JOINTS IN SOLAFES EQUAL TO SIDEWALK WIDTH BUT NOT TO EXCEED 10 FEET. CONCRETE SHALL BE TYPE "A" 3 000 P.S.I. MIN. STRENCTH. EXPANSION JOHN'S SHALL EXTEND ACROSS THE FULL WIDTH OF THE SIDEWALK. CONTROL JOINTS SHALL BE LOCATED ON EACH SDE OF A DRIVEWAY APRON AND NOT MORE THAN 130 FEET APART. PREFORMED BITUMINOUS MATERIAL BE PLACED BETWEEN ALL FIXED OBJECTS AND THE NEW CONCRETE SIDEWALK. NOT TO SCALE


NO3° 20'14"E 99,79' S87° 26'40"E 78.25' N87°37'10"W 78.09' BOUNDARY LINE

LILLY STREET

EXISTING 11" MAGNOLIA O REMAIN \bigcirc^{\triangleleft} EXISTING SITE & CONTOURS 1/16" = 1:-0"

OAK 00

m

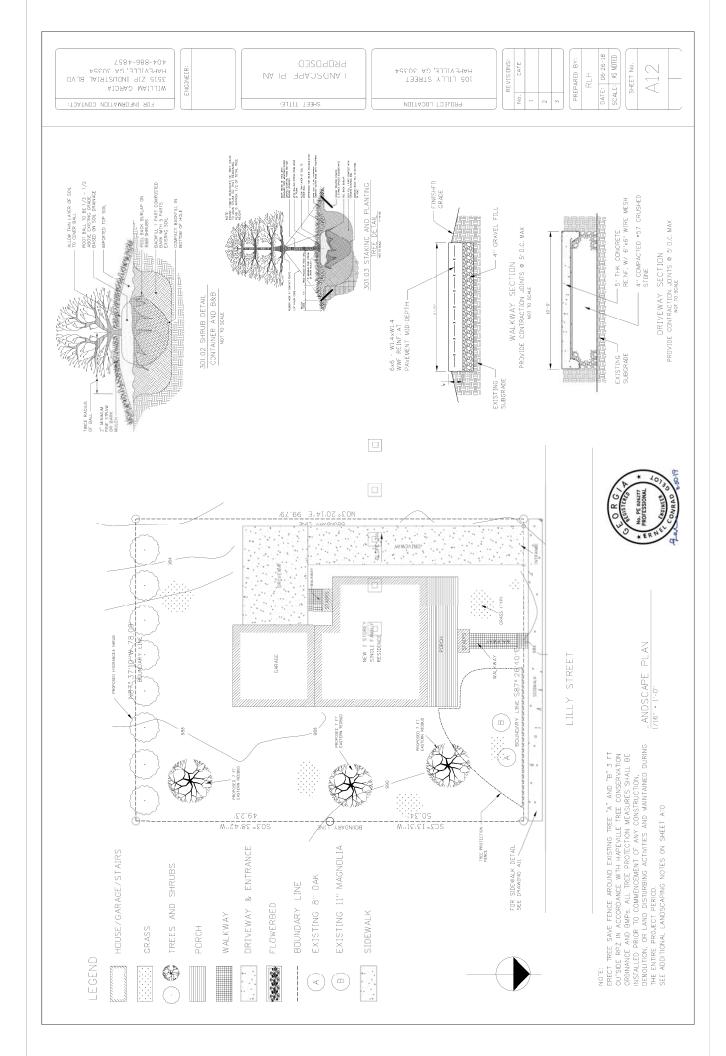



DEPARTMENT OF PLANNING AND ZONING PLANNER'S REPORT

DATE: October 1, 2019
TO: Tonya Hutson
FROM: Michael Smith

RE: Design Review – 591 King Arnold Street, Revised 9-25

BACKGROUND

The City of Hapeville has received updated plans for a design review application from Miller Lowry Developments, LLC, for the designs of 18 proposed townhomes at 591 King Arnold Street. The original application was tabled at the September 18, 2019 meeting of the Design Review Committee.

FINDINGS

The findings of the original planner's report are provided below with updated comments:

1. While the buildings and supplemental area treatments appear compliant, setbacks have not been provided for all buildings. Properties in U-V have no minimum setback and a maximum setback of 15' from the clear area of the sidewalk. Setbacks must be compliant and shown on the drawings.

Setbacks have been provided and are compliant with zoning.

2. First story floor to ceiling height must be 12'. Buildings 13-18 have a first story floor to ceiling height of 10'-6", which is not compliant. The first story floor to ceiling heights have not been provided for the other buildings.

All first story floor to ceiling heights must be at least 12' and be provided on plans.

The applicant has received a design exception.

3. Townhomes must have first story occupiable space for 10' of depth along the enfronting façade. **Buildings 13-18** have entrances on the garage level that have no occupiable space, which is not compliant.

The applicant has received a design exception.

4. Street trees must be planted a maximum of 40' on center in the landscape area of the sidewalk. Street trees are proposed along King Arnold but the spacing has not been provided. No street trees have been proposed along Estelle and North Fulton, which is not compliant. **The applicant must plant the required street trees and show required spacing on plans.** This is also required by U-V zoning.

Street trees in the required configuration are shown on all streets.

5. Fences, walls, or hedges are encouraged by the architectural design standards and are required by U-V zoning along the sidewalks adjacent to the alley. The applicant must add required fences, walls, or hedges to the plans.

The plans show fences and walls along King Arnold, and hedges along the two side streets, which is compliant.

6. **Mechanical utility features should be shown on the plans**. They must be screened from view and may be located on rooftops.

Mechanical features are shown on rooftops.

7. The project must include streetlights.

Compliant.

8. Two-way driveways for townhomes may have a maximum width of 15'. At the request of the fire marshal, the proposed alley is 24' wide, which is not compliant and will require a design exception.

The applicant has received a design exception.

9. The driveway for building 1 appears to be separated from the adjacent sidewalk by less than 10' of landscaped area, which is not compliant and will require a design exception.

The applicant has received a design exception.

10. Fiber-cement siding may not exceed 20% of the total enfronting façade area. While the areas of building façade materials have not been provided, it appears fiber-cement siding constitutes more than 20% of the total façade area of all buildings. The applicant will need to reduce the use of fiber-cement siding to below 20% of the total enfronting façade area or receive a design exception.

The applicant has received a design exception.

11. The enfronting windows proposed for buildings 13-18 are not all equally sized, equally spaced, or arranged in a grid as is encouraged.

Optional.

12. Building numbers are shown on renderings but not on elevations. The plans should be revised to show building numbers on the elevations.

Building numbers are shown on elevations and are more visible on renderings.

13. The entrances for buildings 14-17 do not face, are not visible from, are not accessible from, and are not connected by a walkway to the adjacent public sidewalk, which is not compliant with the architectural design standards or with A-D overlay zoning. The applicant is seeking a Variance from the Board of Appeals for the latter. Regardless of the outcome, the applicant will need to revise the plans to have all buildings front on public streets or receive a design exception.

The applicant has received a design exception.

14. Not all enfronting windows for buildings 13 and 18 are vertically shaped with a height greater than width, which is not compliant.

The applicant has received a design exception.

15. The applicant should ensure no GBGs will be utilized.

The applicant has stated no GBGs will be utilized.

In addition, the plans now show a sidewalk wrapping around units 13-18, similar to what was suggested by the Design Review Committee.

RECOMMENDATION

The applicant has addressed all concerns in the original planner's report and the requirements of the Design Review Committee. Staff recommends approval of the application with the proposed variances.

CITY OF HAPEVILLE DESIGN REVIEW APPLICATION

DATE: 08/20/2019	
All applications must be type authorized representative is required. Meeting to answer questions.	ped or neatly printed. Applications or ar ired to personally appear at the Design Review
Every attempt will be made to month's agenda following the supporting documents; however,	meets the third Wednesday of each month place your application for review on the next submittal of a completed application with that may not always be possible. The City plications as deemed necessary.
Miller Lowry Developments	Contact Number
	Zoning Classification: _∪∨
roposed Work: 591 King Arnold Street, City	y of Hapeville, GA 30354
FORMATION MUST BE PROVIDED):	14 009500040383
	Contact Number: ^{n/a}
ription (including occupancy typ	e):
nt consisting of 18 Townhomes	
ariance (increase the guest parking from 0 to 2 sp	paces)
Name:	Contact Number: _n/a
on: Miller Lowry	Contact Number:
nereby swear or affirm that the informal understand that any inaccuracies may any action taken on this application ght to enforce any and all ordinances restand that it is my/our responsibility to eknowledge that all requirements of the sh language and/or this document has pleted this application. I understand that	e Design Review Committee for the above referenced ation provided here and above is true, complete and by be considered just cause for invalidation of this. I understand that the City of Hapeville, Georgia, gardless of any action or approval on this application. conform with all of City of Hapeville's Ordinances in City of Hapeville shall be adhered to. I can read and been read and explained to me and I have full and it it is a felony to make false statements or writings to 0-20 and I may be prosecuted for violation thereof.
	All applications must be type authorized representative is requived. Meeting to answer questions. The Design Review Committee Every attempt will be made to month's agenda following the supporting documents; however, reserves the right to schedule approximate the right to schedule application and any action taken on this application approximate the right to schedule approximate

xResidential		
	Commercial	Mixed-Use Development
Project Type:		
New Commercial	Construction	Addition to Existing Commercial Building
Addition to Existin	ng Residential Structure	Accessory Structure
	g & Landscaping <u>×</u> Ne	ew Single Family Residential Construction
Other	managad Nava O	~30,000 SE
	proposed New Construction:	
Total Square Footage of	existing building: ~2,000SF	
Estimated Cost of Constr	ruction: ~2.7 million	
Litter and the second		
	terials on the exterior of the	existing structure:
Masonry and wood		
_ist/Describe Building Ma	terials <u>proposed</u> for the exte	rior facade of the new structure:
List/Describe Building Ma Combination of masonry and ha	terials <u>proposed</u> for the exte	rior facade of the new structure:
_ist/Describe Building Ma Combination of masonry and ha	terials <u>proposed</u> for the exte ^{di}	rior facade of the new structure:
_ist/Describe Building Ma Combination of masonry and ha	terials <u>proposed</u> for the exte	rior facade of the new structure:
_ist/Describe Building Ma Combination of masonry and ha	terials <u>proposed</u> for the exte ^{rdi}	rior facade of the new structure:
_ist/Describe Building Ma Combination of masonry and ha	terials <u>proposed</u> for the exte	rior facade of the new structure:
_ist/Describe Building Ma Combination of masonry and ha	terials <u>proposed</u> for the exte	rior facade of the new structure:

NOTICE

Please be advised that the Community Service Department is here to assist all applicants regarding application procedures, meeting schedules and necessary deadlines. The Community Service Department does **NOT** make any final decisions for the Design Review Committee, Sign Committee, Planning Commission, Board of Appeals or rezoning request to Mayor and Council.

A complete application must be submitted before the Community Service Department will accept an application and forward the same to the appropriate entity.

Building inspections issued by the City of Hapeville are contracted out to State of Georgia Certified Inspectors. These inspectors make the final decisions regarding building, electrical, plumbing and HVAC work completed in the City of Hapeville. The Hapeville Fire Marshal conducts inspections issued through the Community Services Department as needed. Both the Certified Inspectors and Fire Marshal make the final decisions before Certificates of Occupancy's are issued.

Please be advised that the Community Service Department shall not be responsible for your purchasing materials, equipment, items, signs, etc... before you receive final approval by any entity whose approval is required.

I understand that it is a felony to make false statements or writings to the City of Hapeville, Georgia pursuant to O.C.G.A. 16-10-20 and I may be prosecuted for a violation thereof.

(Please Print & Initial)

| ______swear or affirm that before receipt of an application, I have received this notice and I read and write the English language or I have had someone read and explain this document to me.



DEPARTMENT OF PLANNING AND ZONING

DESIGN REVIEW APPLICATION INSTRUCTIONS AND ACKNOWLEDGEMENT

I, the undersigned, agree that with my signature and submission to the City of Hapeville, I have done the

follo	owing:
	Read the City of Hapeville's Architectural Design Guidelines and relevant Code sections for my proposed project. The Architectural Design Guidelines may be found here: s://library.municode.com/ga/hapeville/codes/code of ordinances?nodeId=PTIICOOR CH81ARDEST
<u>M(</u>	Ensured that my proposed project meets all of the required criteria per the City of Hapeville Code of Ordinances.
m l	_Submitted my application materials in full by the published deadline for review by Staff prior to the Design Review Committee meeting.
<u>u(</u>	_Identified and explained all deficiencies or components of the proposed project that do not meet with the requirements set forth in the Code. This explanation should be submitted as a separate document in the application.
M(Understood that any deficiencies in the application must be resolved at least 10 days prior to the Design Review Committee meeting or the application may not be presented to the DRC for review.
mſ	_ Submitted architectural drawings and details for all projects unless allowed in writing by the Community Services or Planning & Zoning Department.
W(Agreed to submit any required revisions by the Design Review Committee with updated drawings to the Community Services Department for review prior to requesting any permits.

Should you have any questions, please do not hesitate to contact the Community Services Department at 404-669-2120.

Signature

Thank you for interest and investment in the City of Hapeville.

SITE NOTES:

THE SITE CONTAINS: 0.993 ACRES / 43241 SF TOTAL DISTURBED AREA: 0.90 ACRES

SITE ADDRESS: PROPERTY ENJOINED BY ESTELLE STREET, KING ARNOLD STREET AND NORTH FULTON AVENUE, FULTON COUNTY, GA 30354

ZONING: U-V URBAN VILLAGE DISTRICT

BOUNDARY SURVEY INFORMATION TAKEN FROM SURVEY PERFORMED BY DELTA 1 LAND SURVEYING, LLC, DATED 5 OF MARCH, 2019.

A PORTION OF THIS SITE IS LOCATED WITHIN A FLOOD ZONE [A, AE, SHADED ZONE X] AS DEFINED BY FIRM PANEL NUMBER 13121C0366 F DATED SEPTEMBER 18, 2013, FOR FULTON COUNTY AND INCORPORATED AREAS.

THERE ARE NO WATERS OF THE STATE OF GEORGIA OR WETLANDS WITHIN 200 FEET OF THE SITE. ALL APPROPRIATE STATE WATER BUFFERS ARE SHOWN ON THE SITE PLANS. THERE ARE NO PROPOSED IMPACTS TO ANY STATE WATER BUFFERS.

TO THE BEST OF OUR KNOWLEDGE, NO CEMETERIES, ARCHITECTURAL, OR ARCHEOLOGICAL LANDMARKS EXIST ON SITE. IN THE EVENT THAT THESE LANDMARKS ARE DISCOVERED DURING CONSTRUCTION, THE ENGINEER MUST BE CONTACTED IMMEDIATELY FOR REVIEW AND AMENDING THE CONSTRUCTION PLANS

BUILDING FOUNDATION & LAYOUT SHALL BE COORDINATED USING ARCHITECTURAL DRAWINGS. ARCHITECTURAL DRAWINGS TAKE PRECEDENCE OVER CIVIL DRAWINGS CONCERNING FOUNDATIONS AND ALIGNMENT WITH EXISTING STRUCTURES OR SURVEY.

THE CONTRACTOR SHALL IMMEDIATELY NOTIFY THE ENGINEER OF ANY DISCREPANCIES OR ERRORS THAT HE MAY DISCOVER IN THESE PLANS.

CONTRACTOR TO PROVIDE ALL NECESSARY BARRICADES, GUARDS, LIGHTS, AND OTHER INSTALLATIONS REQUIRED TO PROTECT PERSONS AND PROPERTY DURING THE ENTIRE CONSTRUCTION PROCESS.

SITE DATA:

TOTAL NUMBER OF PROPOSED UNITS:

TOWNHOME UNITS: 18

ZONING:U-V: URBAN VILLAGE


VARIANCES REQUESTED:

1. GUEST PARKING FROM 0 SPACES TO 2 SPACES


24 HOUR EMERGENCY CONTACT: MILLER LOWRY 770-289-9179
CONSTRUCTION DOCUMENTS FOR:

KING ARNOLD TOWNHOMES

LAND LOT 89 & 127 DISTRICT 14 CITY OF HAPEVILLE, FULTON COUNTY, GEORGIA 30350

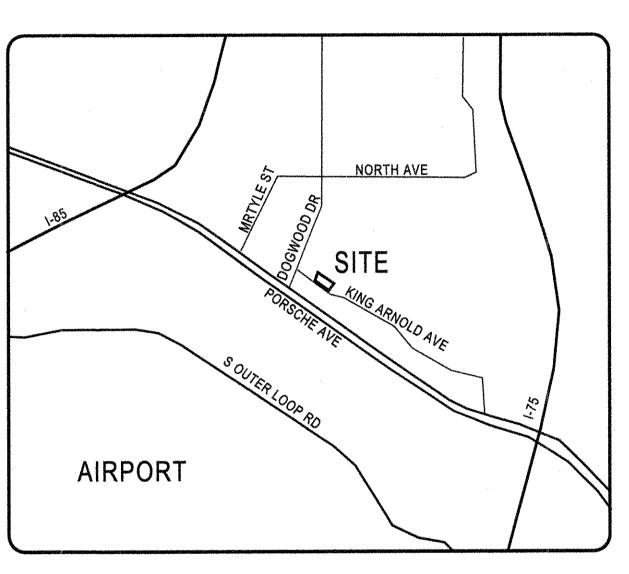

Location Map

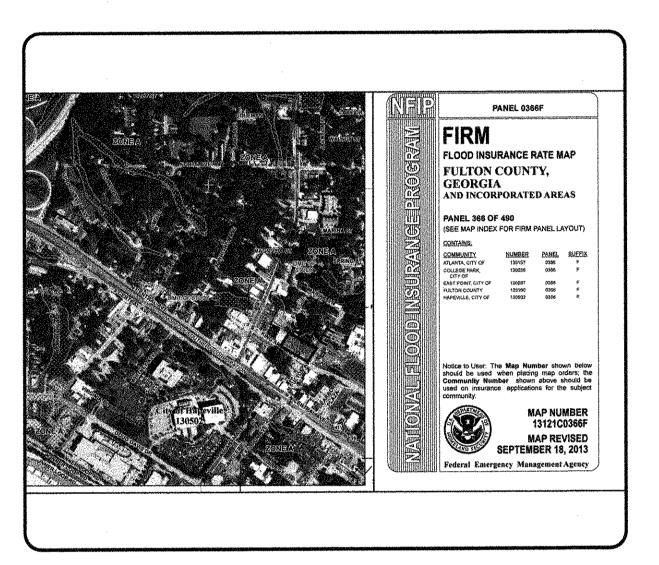

FEMA Map

Construction Activity Schedule JUL AUG SEP OCT NOV DEC JAN FEB MAR A) INITIAL EROSION CONTROL & TREE SAVE BMPS INSTALLATION B) INTERMEDIATE EROSION CONTROL BMPS C) FINAL PHASE E&SC BMPS D) MAINTENANCE OF E&SC PRACTICES E) DEMOLITION F) INSTALLATION/REMOVAL OF TEMPORARY SEDIMENT BASINS G) CLEARING AND GRUBBING H) GRADING I) STORM AND SANITARY SEWER INSTALLATION J) PAVING K) BUILDING CONSTRUCTION L) TEMPORARY GRASSING @ 14 DAY INTERVALS M) PERMANENT GRASSING @ 30 DAY INTERVALS N) REMOVAL OF TEMPORARY BMP'S O) FINAL CLEAN-UP

ANTICIPATED START DATE: 7-17-19 ANTICIPATED COMPLETION DATE: 3-5-19

CONSTRUCTION NARRATIVE:

THE PROPOSED PLANS CALL FOR THE CONSTRUCTION OF 18 TOWNHOUSE UNITS AND ACCOMPANYING INFRASTRUCTURE. ALL PHASED EROSION CONTROL BMPS ARE TO REMAIN IN PLACE UNTIL THE SITE IS 100% STABILIZED.

<u>OWNER</u>

MILLER LOWRY DEVELOPMENTS, LLC 2964 PEACHTREE ROAD NW SUITE 540 HAPEVILLE, GA 30305

ENGINEER:

CRESCENT VIEW ENGINEERING 211 FRASIER STREET, NE MARIETTA, GEORGIA 30060

SHEET LIST TABLE

DRIVEWAY PLAN AND PROFILE

GRADING AND DRAINAGE PLAN

EROSION CONTROL PLAN

CONSTRUCTION DETAILS

CONSTRUCTION DETAILS

CONSTRUCTION DETAILS

CONSTRUCTION DETAILS

CONSTRUCTION DETAILS

STORMWATER MANAGEMENT PLAN

UTILITY NOTES + FIRE FLOW TESTS

COVER SHEET

DEMOLITION PLAN

SURVEY

SITE PLAN

UTILITY PLAN

ES&PC - DETAILS

SHEET TITLE

SHEET NO.

C1.1

C-2.1

C-4.1

C-5.1

C-5.2

C-5.3

C-5.4

UTILITY CONTACTS:

TELEPHONE: ELECTRIC: WATER & SEWER

AT&T
GEORGIA POWER COMPANY
CITY OF HAPEVILLE
ATLANTA GAS LIGHT COMPANY

800-225-5288 888-655-5888 404-669-2100 877-427-4321

iller Lowry Developments, Ll
2964 Peachtree Road NW Suite 540
HAPEVILLE, GA 30305

DATE 7-8-19 REVISION SCALE AS SHOWN A R.



King Arnold Townhomes
Land Lots 95 & 98, 14th District
City of Hapeville, Fulton County, Georgia

CVE PI# 18-403

Sheet No.

CLERK'S OFFICE: RECORDING INFORMATION ONLY

591 KING ARNOLD STREET HAPEVILLE, GA 30354

THE UNDERGROUND UTILITIES SHOWN HEREON ARE BASED ON LOCATION OF MARKINGS PROVIDED BY:

1127 NORTH PEACHTREE PKWY., SUITE 178
PEACHTREE CITY, GA 30289
PHONE: 404-312-6912

THE UNDERGROUND UTILITIES (EXCEPT THE LOCATION OF EXISTING DRAINAGE, SEWER AND IRRIGATION UTILITIES AS WELL AS UNDERGROUND STORAGE TANKS) WERE LOCATED BY UTILISURVEY, LLC. UTILIZING RADIO FREQUENCY TECHNIQUE. THIS TECHNIQUE IS CAPABLE OF LOCATING METALLIC UTILITIES AND TRACER WIRES. ANY NON-METALLIC UTILITIES (WITHOUT TRACER WIRE) ARE NOT LOCATED.

THE SURVEYOR MAKES NO GUARANTEES THAT THE UNDERGROUND UTILITIES SHOWN COMPRISE ALL SUCH UTILITIES IN THE AREA, EITHER IN-SERVICE OR ABANDONED. UNDERGROUND UTILITIES NOT OBSERVED OR LOCATED UTILIZING THIS TECHNIQUE MAY EXIST ON THIS SITE BUT NOT BE SHOWN, AND MAY BE FOUND UPON EXCAVATION. THE SURVEYOR FURTHER DOES NOT WARRANT THAT THE UNDERGROUND UTILITIES SHOWN ARE IN THE EXACT LOCATION INDICATED ALTHOUGH THE SURVEYOR DOES CERTIFY THAT THEY ARE LOCATED AS ACCURATELY AS POSSIBLE FROM INFORMATION AVAILABLE.

INFORMATION REGARDING MATERIAL AND SIZE OF UTILITIES IS BASED ON RECORDS ACQUIRED FROM THE UTILITY OWNERS.

UNDERGROUND UTILITY LEGEND

GAS = GAS LINE

UGT = UNDERGROUND TELEPHONE


P = UNDERGROUND POWER


L = UNDERGROUND POWER FOR LIGHT POLES

-----SS --- = SANITARY SEWER - WATER LINE

CONTRACTOR SHALL HAVE UNDERGROUND UTILITIES RE-MARKED PRIOR TO ANY EARTH DISTURBING ACTIVITIES.

ABBREVIATIONS ~			
ABL = ABELIA		■ HYDRANGEA	
AUC = AUCUBA	ICV	= IRRIGATION CONTROL VALVE	
AHY - AMERICAN HOLLY	IMP	= IMPATIENS	
AZ = AZALEA	IPF	= IRON PIN FOUND	
AZ == AZALEA BB == BARBERRY BE == BEECU	JAS	- JASMINE	
pe # oceup	MY	= JAPANESE HOLLY	
BEG = BEGONIA BHY = BURFORD HOLLY	M	= JAPANESE MAPLE	
BHY = BURFORD HOLLY	JUN		
BIR = BIRCH	LIR		
BP - BRADFORD PEAR	LL	= LAWN LIMITS	
BW = BOXWOOD	MAG	■ MAGNOLIA	
CAL = CALADIUM	MAP	■ MAPLE	
CAM - CAMELLIA	NAN	■ MAPLE ■ NANDINA	
CE - COTONEASTER	OGH	= OREGON GRAPE HOLLY	
CED ** CEDAK	OLL	- OTTOLUYKEN LAUREL	
THEY ME TIME POPLY	P	= PINE = PHOTINIA	
CHN = CHESTNUT	POP	= POPLAR	
	RHO		
CJ = CRYPTOMERIA JAPONICA	RO	= RED OAK	
CL = CHERRY LAUREL CO = CLEAN OUT CM = CRAPE MYRILE	RT	- RED TIP	
CO - CLEAN OUT	SG	= SWEET GUM	
CM - CRAPE MYRTLE	SP	- SPRUCE	
DG == DWARF GARDENIA	SPIG	= SPIGOT	
DS - DOWNSPOUT	SPK	= SPRINKLER	
DW = DOGWOOD	SW	<i>≖ SOURWOOD</i>	
EL = ELAEAGNUS	UDS	= UNDERGROUND DOWNSPOUT	
EM = ELECTRIC METER	UNK	= UNKNOWN	
ET - EXTERIOR THRESHOLD			
FF = FINISH FLOOR FOR = FORSYTHIA	VLIR	= VARIEGATED LIRIOPE	
		- VARIEGATED PRIVET	
GE - GOLDEN EUONYMUS	VW	= VENT WELL	
GLF = GROUND LIGHT FIXTURE	WAO	= WATER OAK	
GM = GAS METER	WLO	= WILLOW OAK	
GM = GAS METER HB = HACKBERRY HEM = HEMLOCK	WIL	= WLLOW	
HEM - HEMLOCK	MM	= WATER METER	
HIC = HICKORY HH = HELLERI HOLLY	WO	- WHITE OAK	
	Mb		
HOS = HOSTA		= MINDOW WELL	
HLY - HOLLY	n	= YARD INLET	

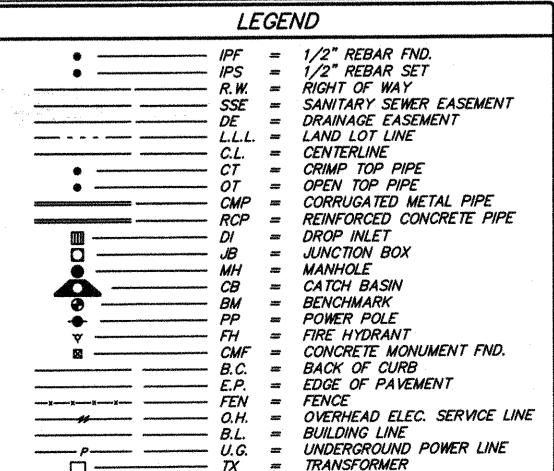


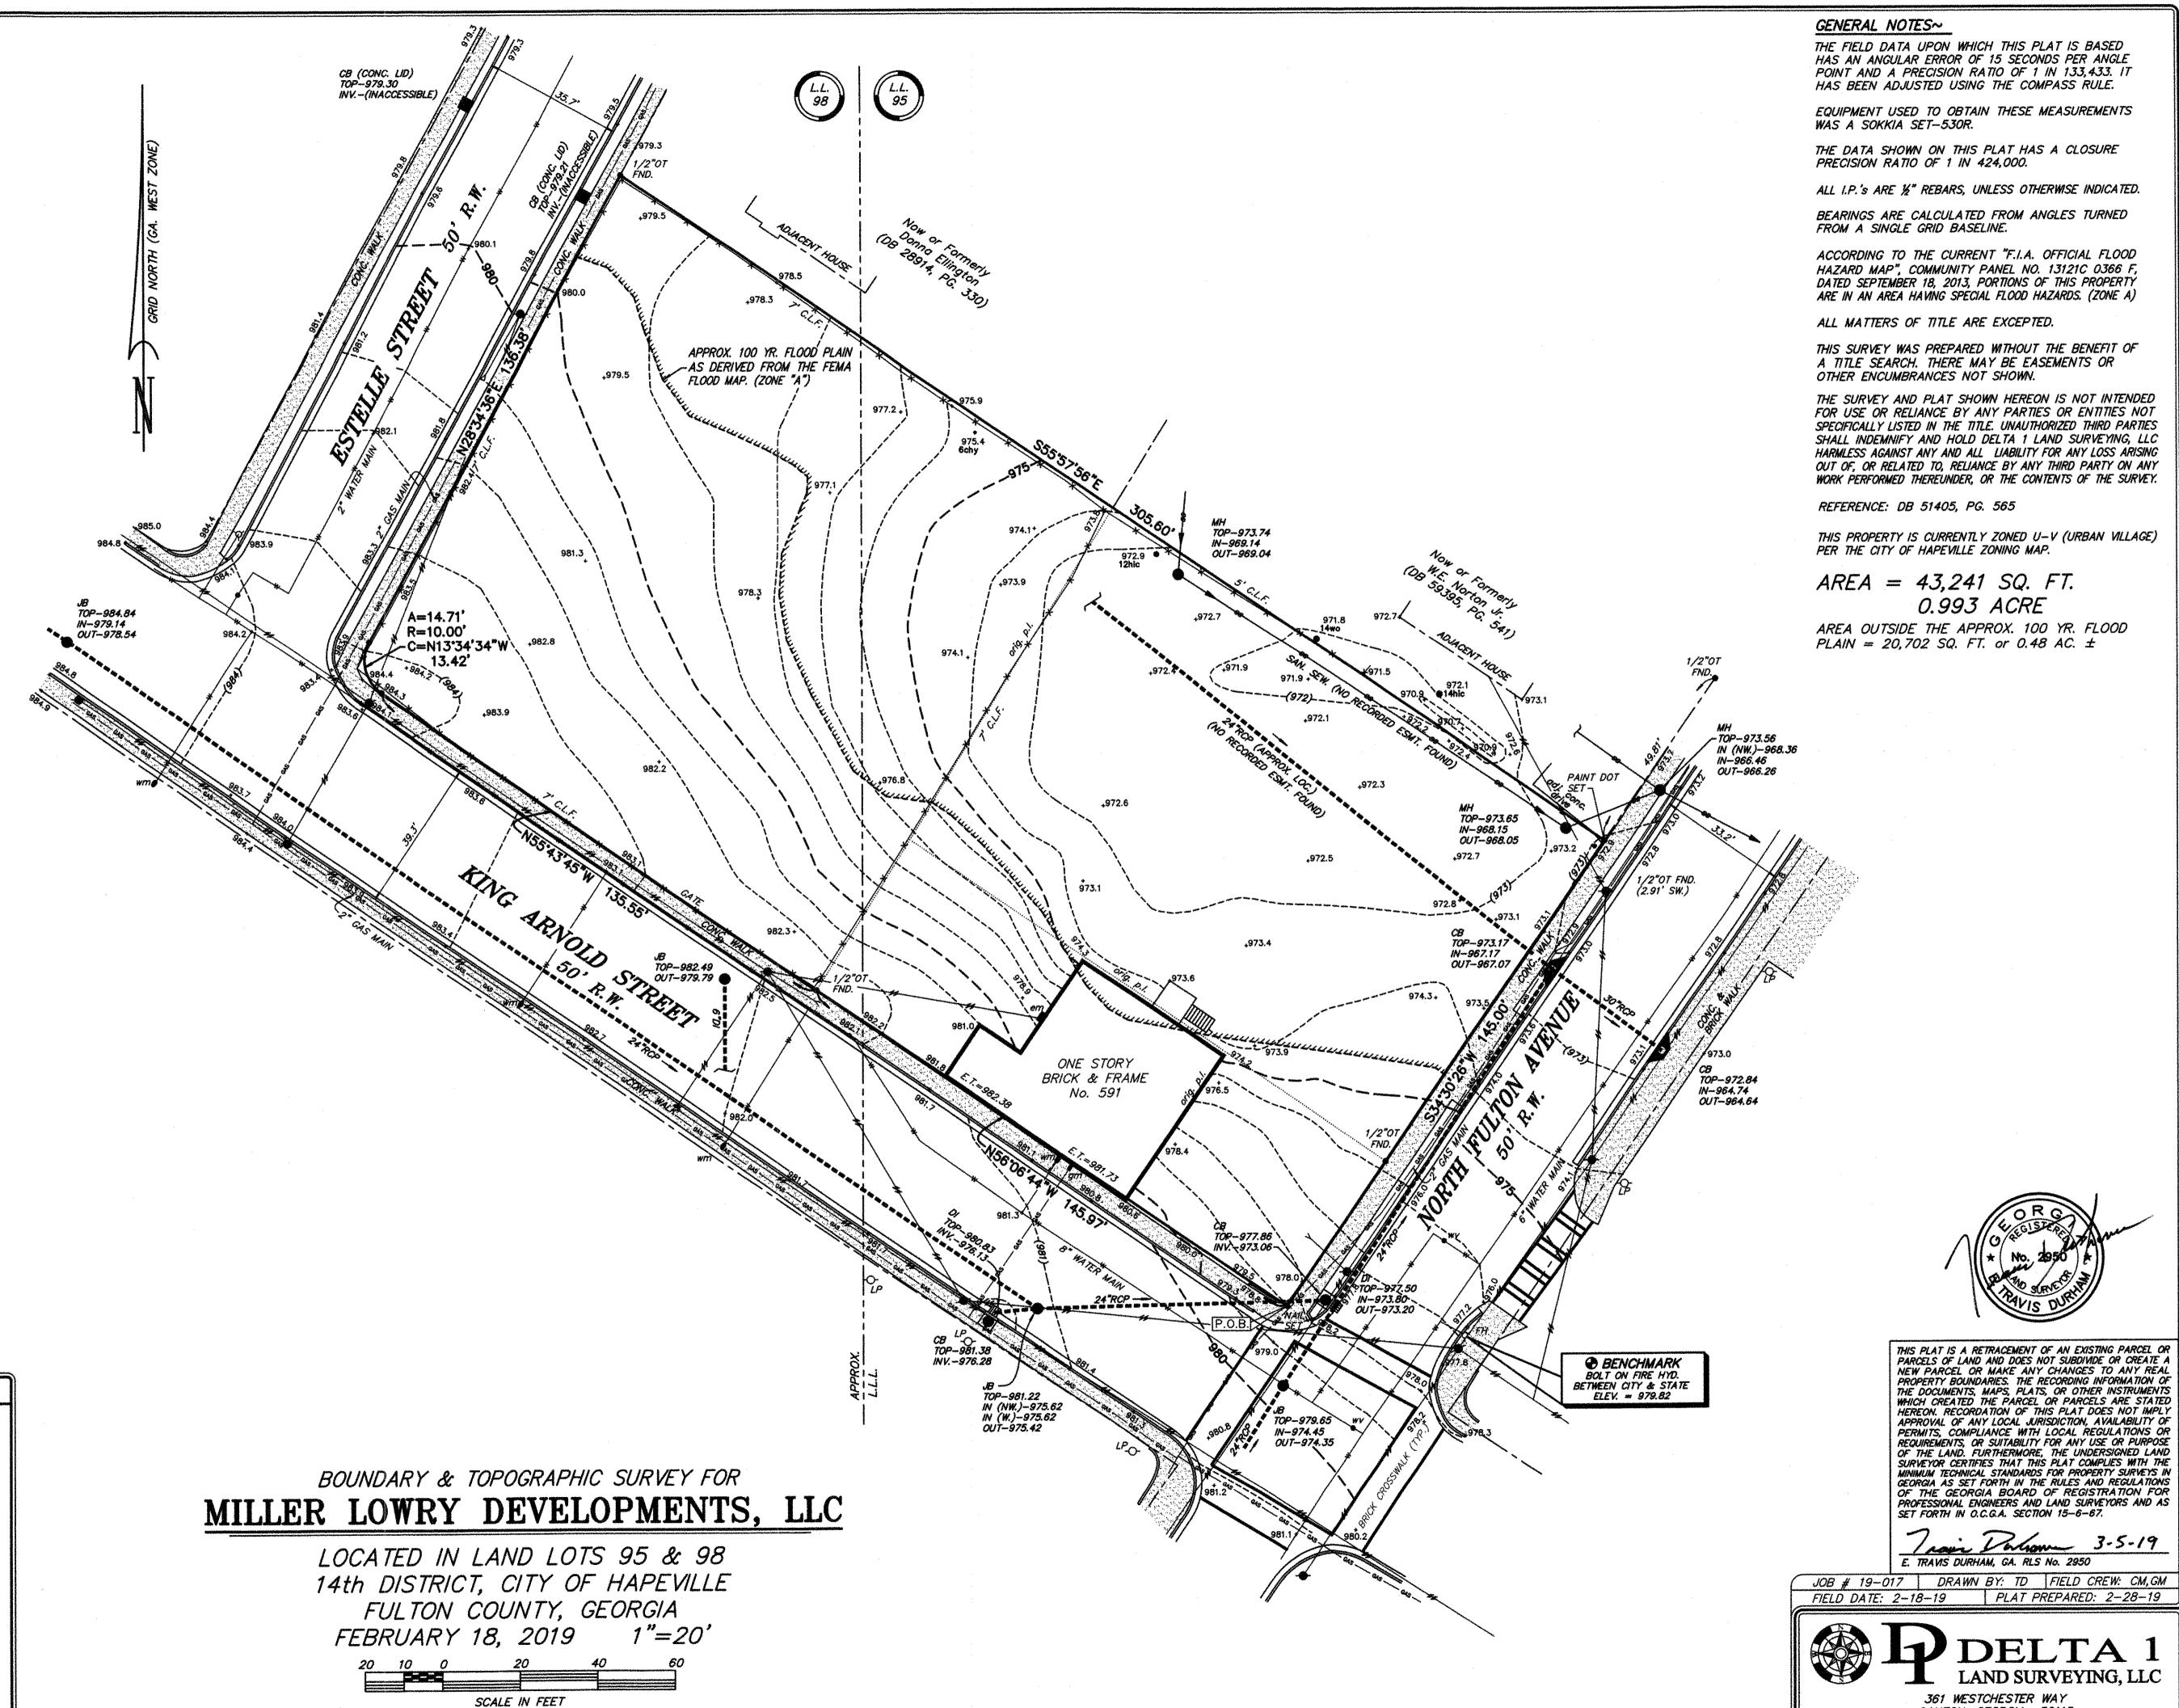

CONTOUR INTERVAL = 2 FT. VERTICAL DATUM IS MEAN SEA LEVEL (NAVD 1988) 0.993 ACRE

LAND SURVEYING, LLC

361 WESTCHESTER WAY CANTON, GEORGIA 30115 PHONE: (770) 597—3533 (FIRM LICENSE No. LSF 001041)

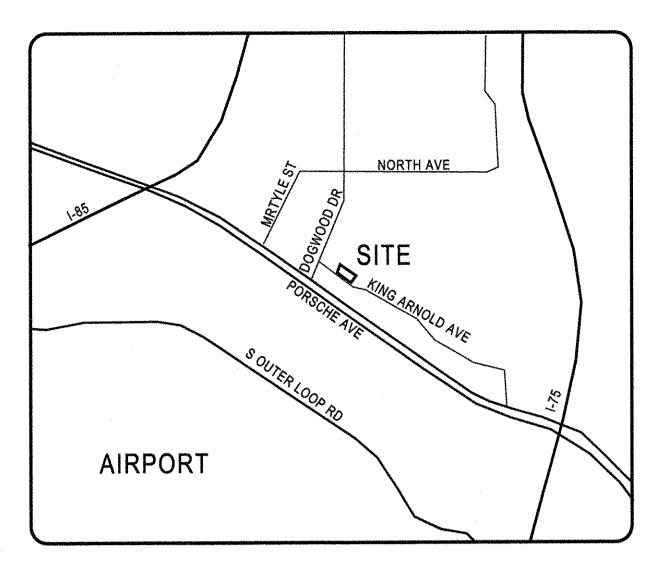

Location Map

SITE NOTES:

THE SITE CONTAINS: 0.993 ACRES / 43241 SF TOTAL DISTURBED AREA: 0.90 ACRES

SITE ADDRESS: PROPERTY ENJOINED BY ESTELLE STREET, KING ARNOLD STREET AND NORTH FULTON AVENUE, FULTON COUNTY, GA 30354

ZONING: U-V URBAN VILLAGE DISTRICT

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SITE DATA:


TOTAL NUMBER OF PROPOSED UNITS:

TOWNHOME UNITS: 18

ZONING:U-V: URBAN VILLAGE

VARIANCES REQUESTED:

1. GUEST PARKING FROM 0 SPACES TO 2 SPACES

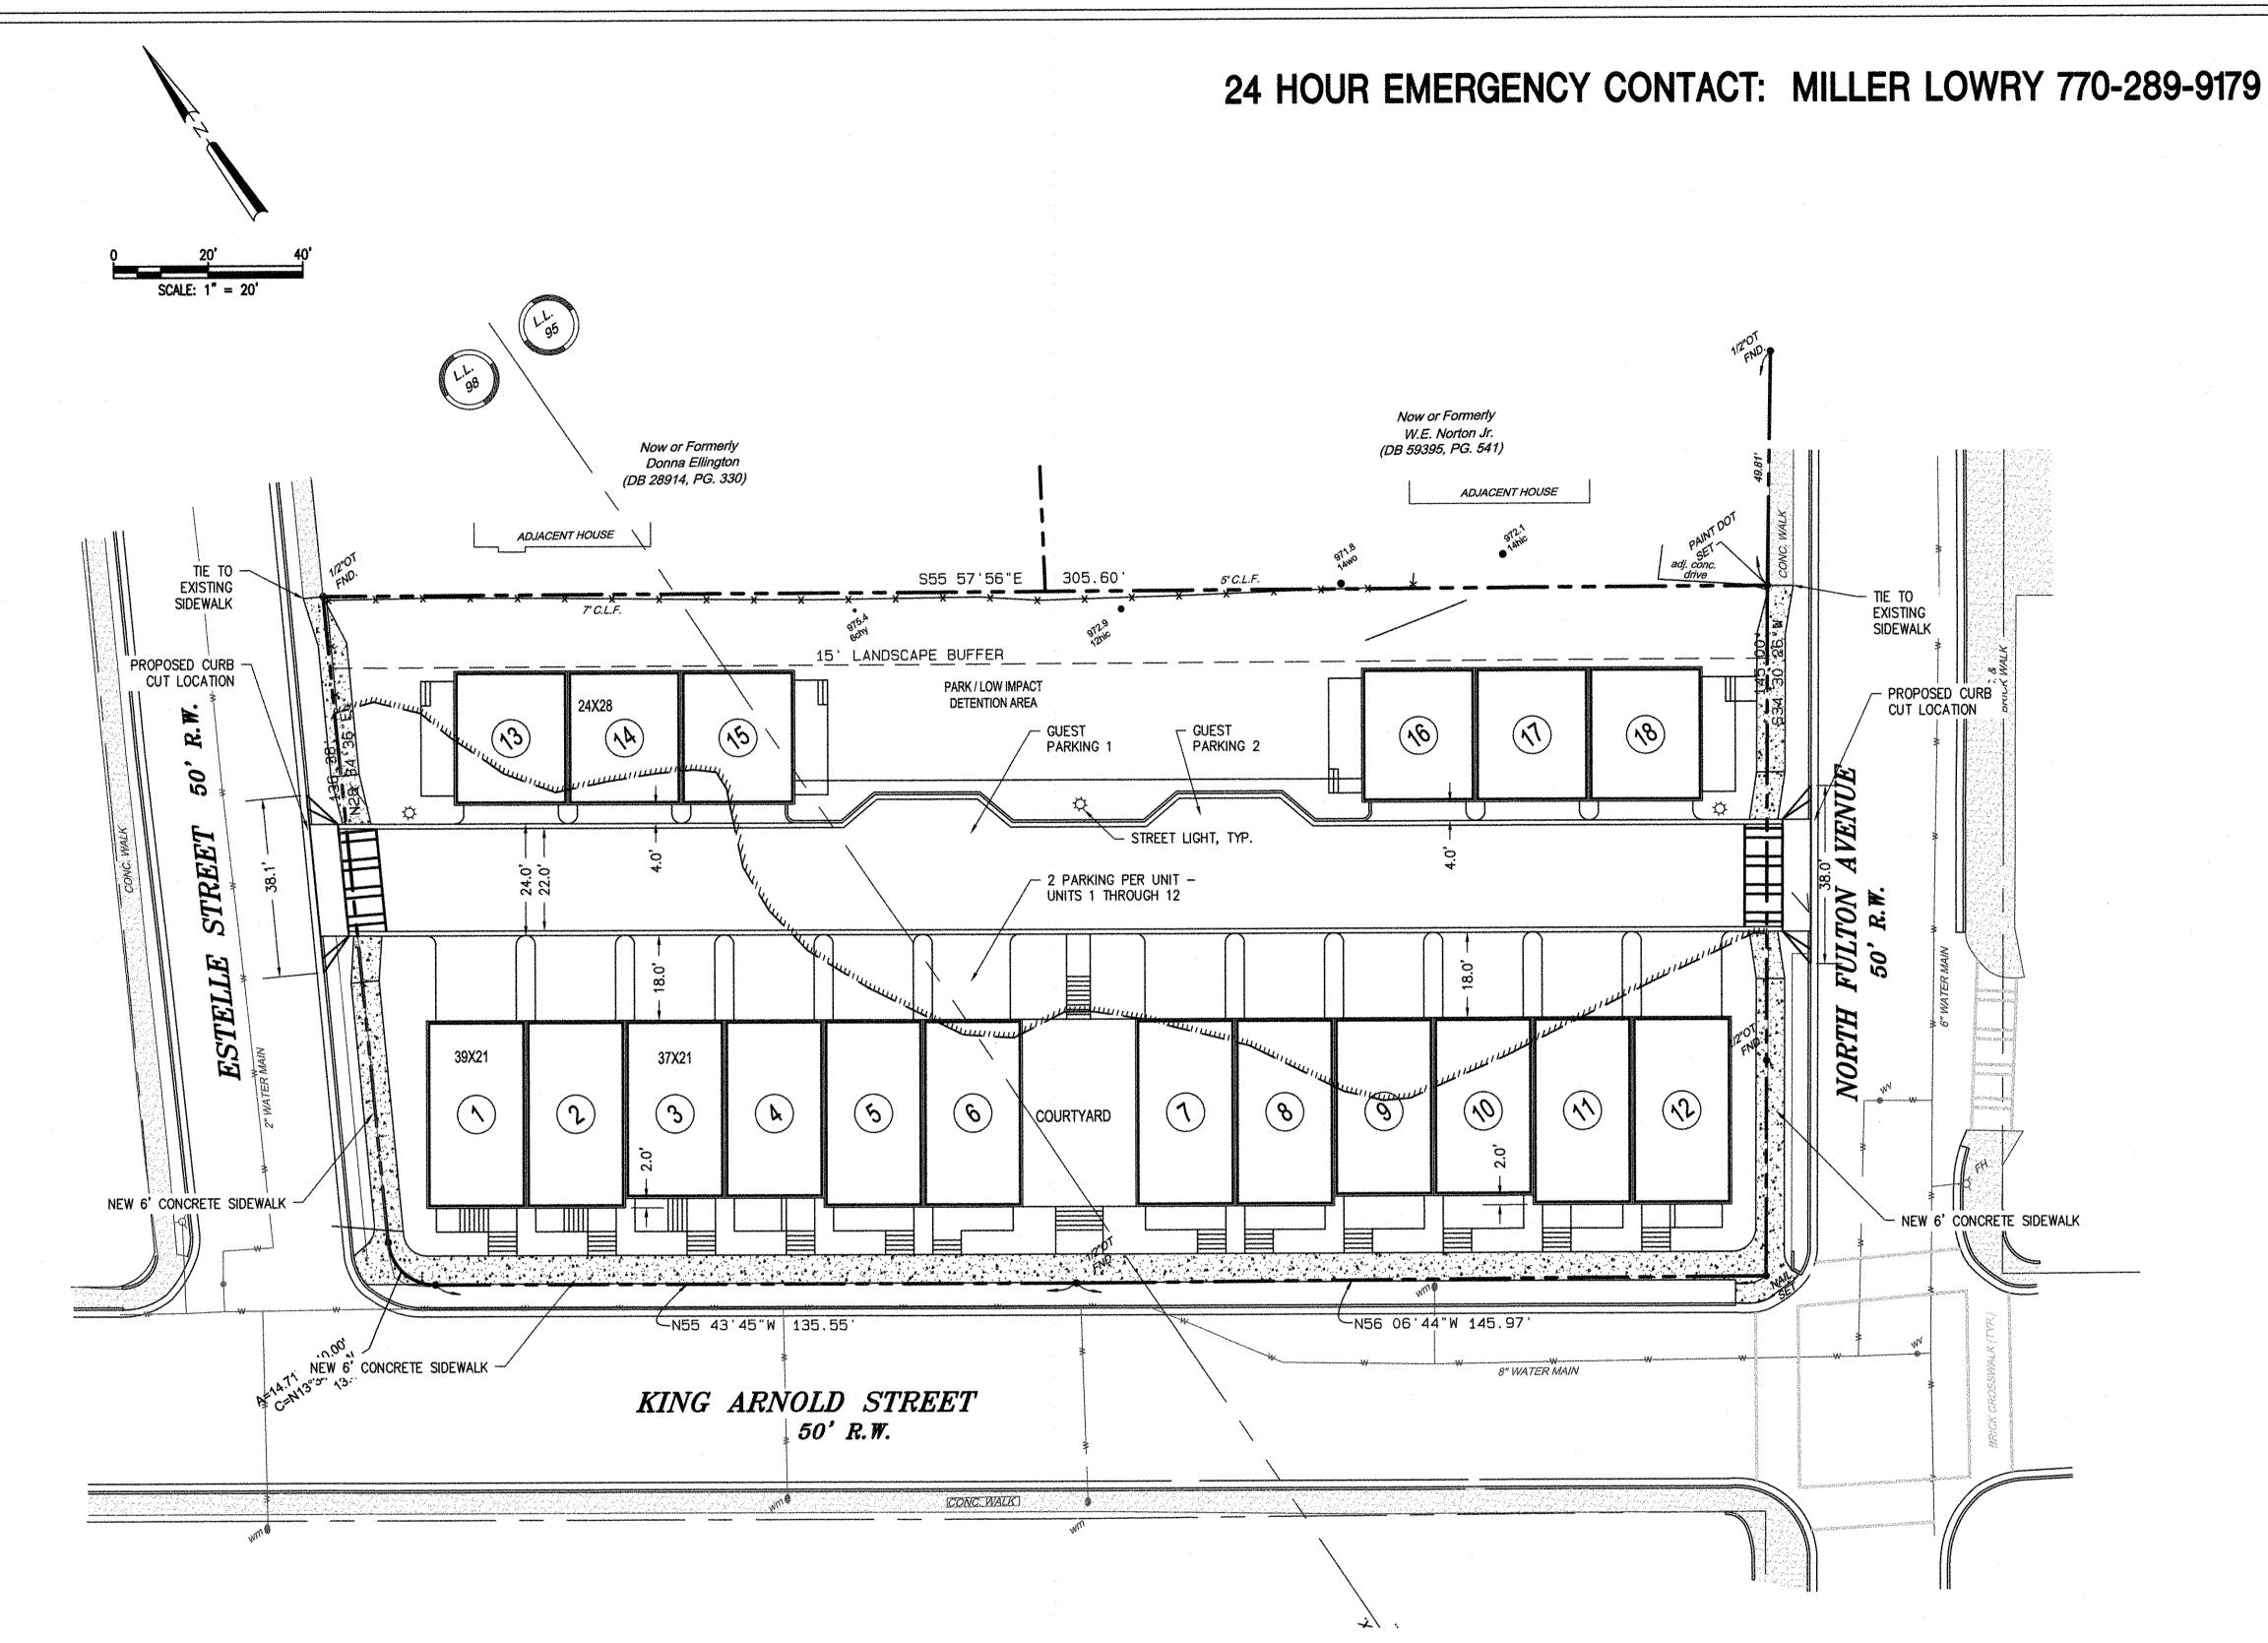

CATAGORY	REQUIREMENT	PROVIDED
PERMITTED USES	SINGLE FAMILY ATTACHED DWELLING, COMMERCIAL/RETAIL	SINGLE FAMILY ATTACHED DWELLING
LOT FRONTAGE	20' (MIN) FRONTAGE	LOT FRONTAGE PROVIDED = 560'
STREET FRONTAGE SETBACK	5' PLANT ZONE / 6' SIDEWALK CLAR ZONE / 5' SUPPLEMENTAL ZONE	5' PLANT ZONE / 6' SIDEWALK CLAR ZONE / 5' SUPPLEMENTAL ZONE
REAR YARDS	o' FT	O' FT
DISTANCE BETWEEN BUILDINGS	20' MIN DISTANCE BETWEEN BUILDINGS, PLUS 4 ADDITIONAL FEET FOR EVERY STORY (OR FRACTION THEREOF), THAT EXCEEDS 2 STORIES	PROVIDED DISTANCE BETWEEN BUILDINGS: - BETWEEN UNITS 6 AND 7 = 24.0'
HEIGHT REGULATIONS	2.5 STORIES, OR 35' IN HEIGHT	PROVIDED HEIGHT NOT TO EXCEED 2.5 STORIES, OR 35' IN HEIGHT
RESIDENTIAL BUFFER	15' LANDSCAPED BUFFER BORDERING RESIDENTIAL ZONING	15' LANDSCAPED BUFFER PROVIDED.
<u>PARKING</u> RESIDENTIAL -	2 SPACES REQUIRED/ PER UNIT	2 SPACES PROVIDED / PER UNIT

APPLICANT / DEVELOPER

MILLER LOWRY DEVELOPMENTS, LLC 2964 PEACHTREE ROAD NW SUITE 540 HAPEVILLE, GA 30305 Prepared By:
CRESCENT VIEW
ENGINEERING, LLC
211 Frasier Street SE
Marietta, GA 30060
678-324-8410

er Lowry Developments, LL

Site Plan

DATE 7-8-19
SCALE AS SHOWN





King Arnold Townhomes

Land Lots 95 & 98, 14th District
City of Hapeville, Fulton County, Georgia

CVE PI # 18-403

Sheet No.

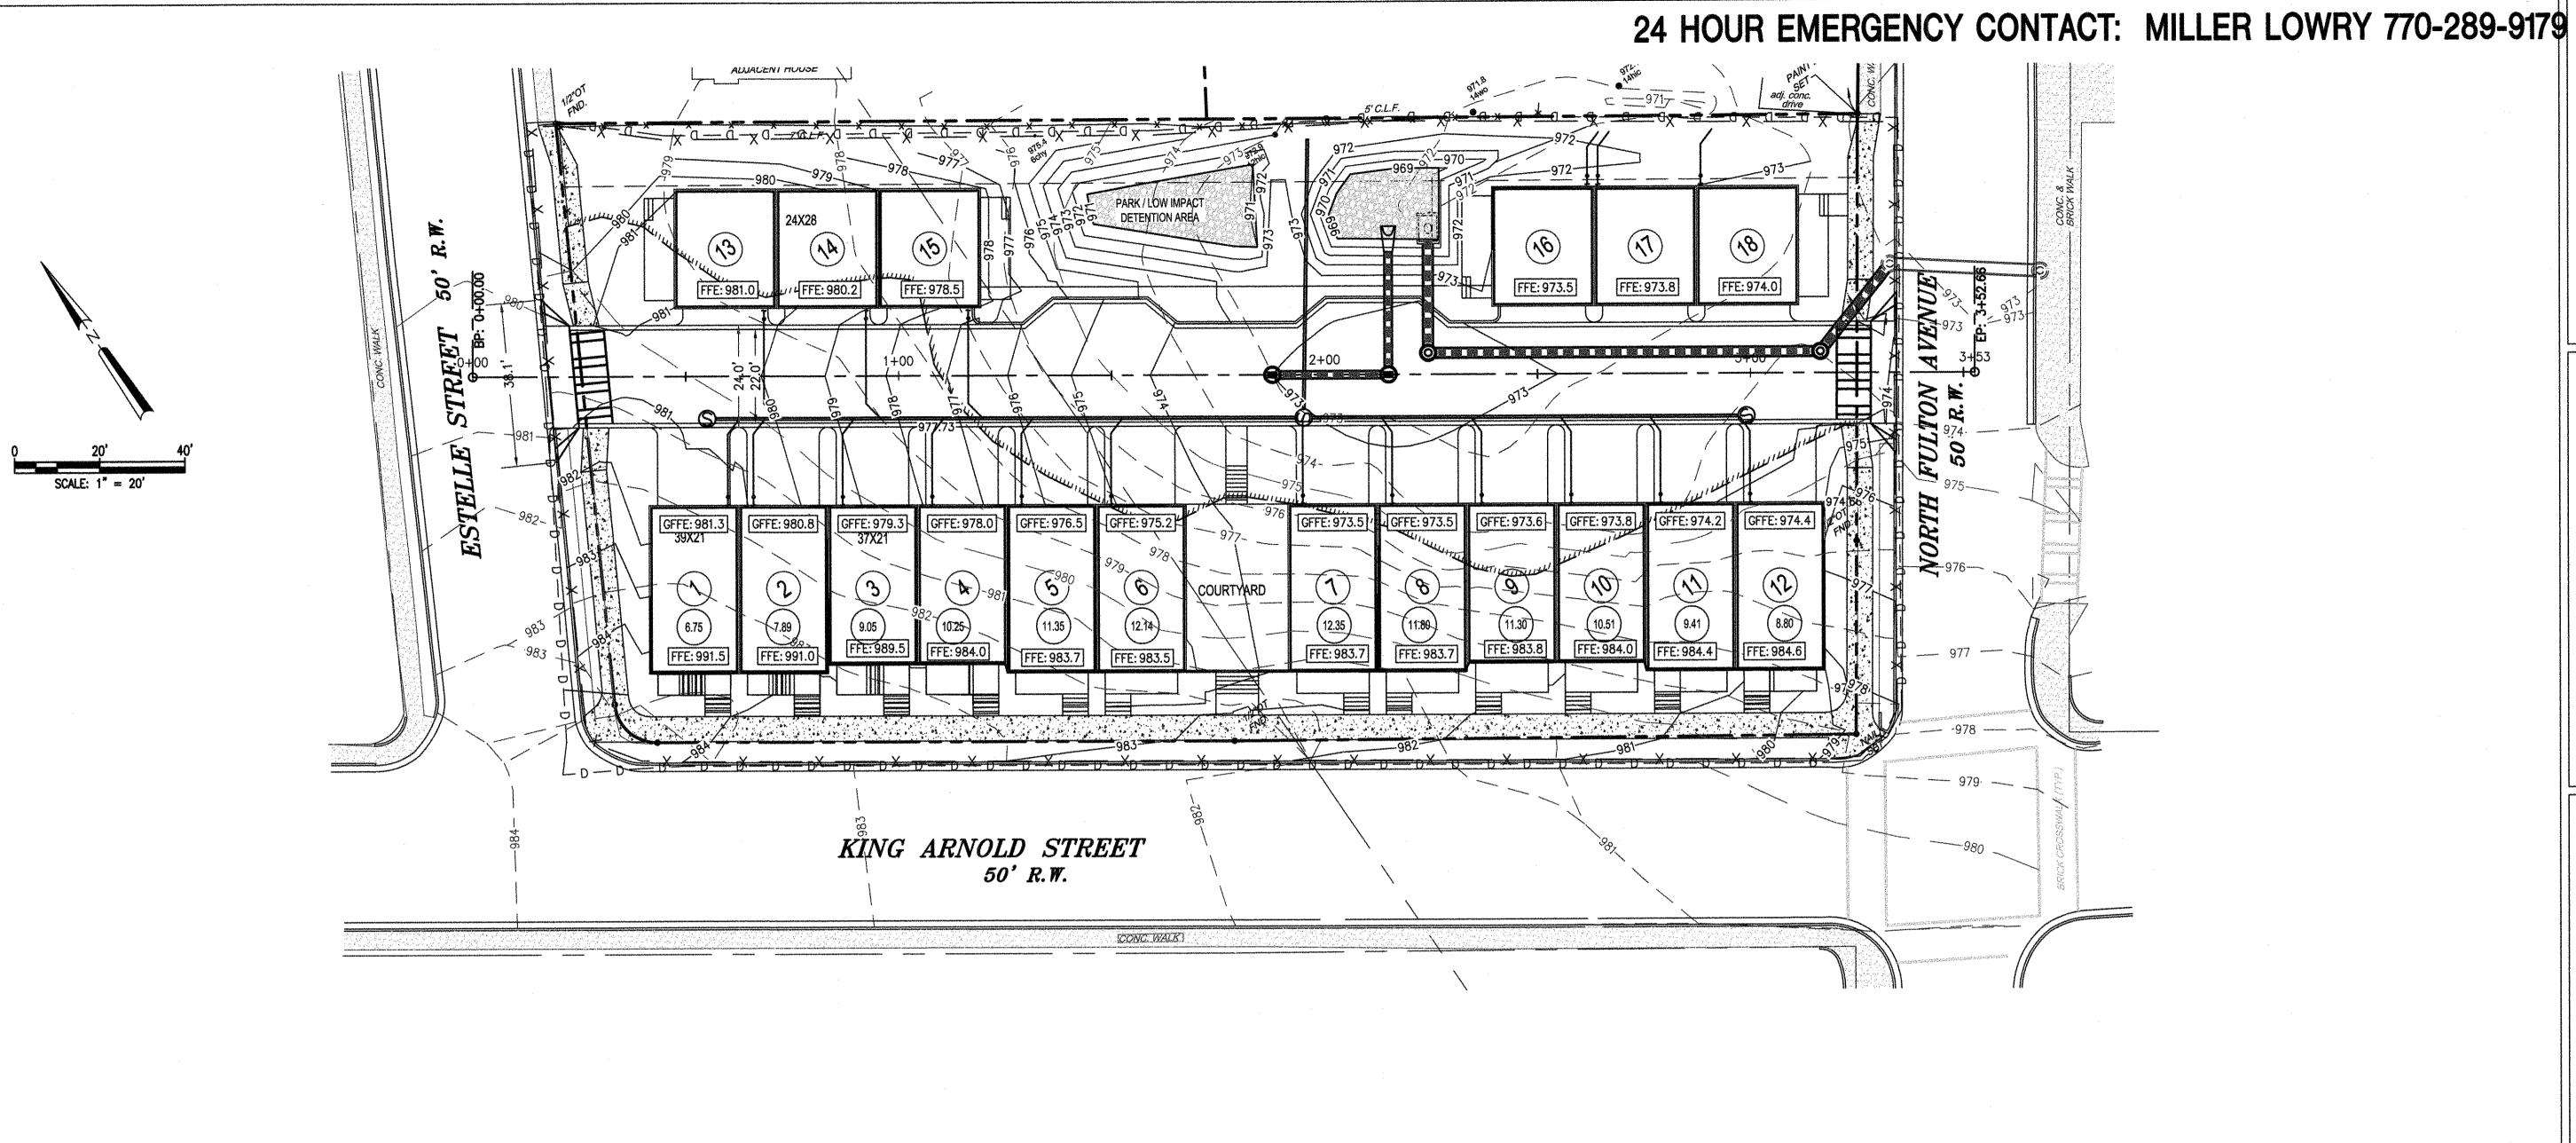

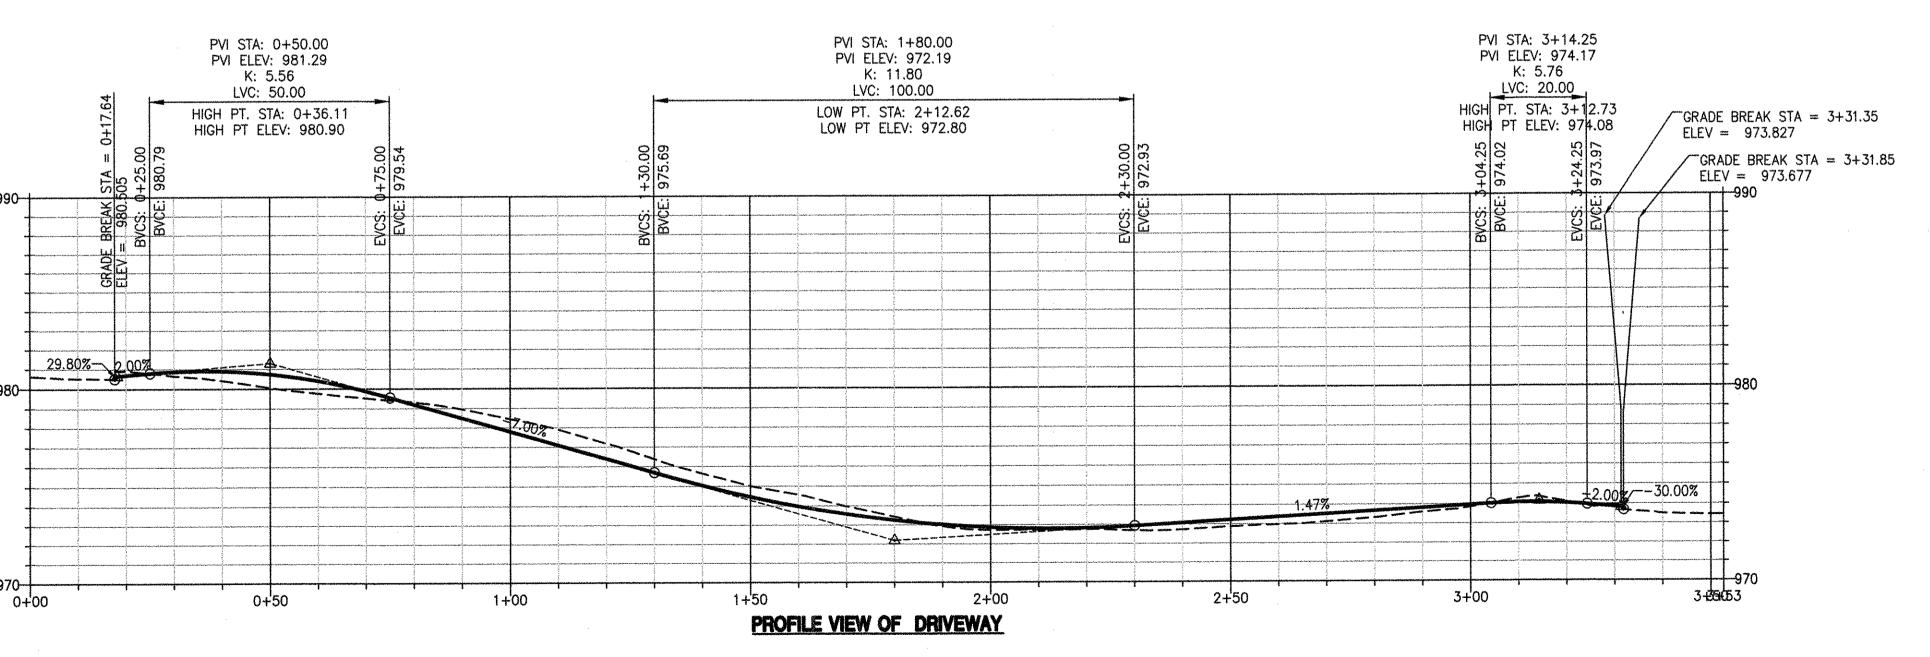

Prepared By:
CRESCENT VIEW
ENGINEERING, LLC:
211 Frasier Street SE
Marietta, GA 30060
678-324-8410

Prepared For:

er Lowry Developments, LL
2964 Peachtree Road NW Suite 540
HAPEVILLE, GA 30305

Driveway Plan and Profile



Construction Plan Set For:

King Arnold Townhomes


Land Lots 95 & 98, 14th District

City of Hapeville, Fulton County, Georgia

CVE PI # 18-403

Sheet No.

C-1.1

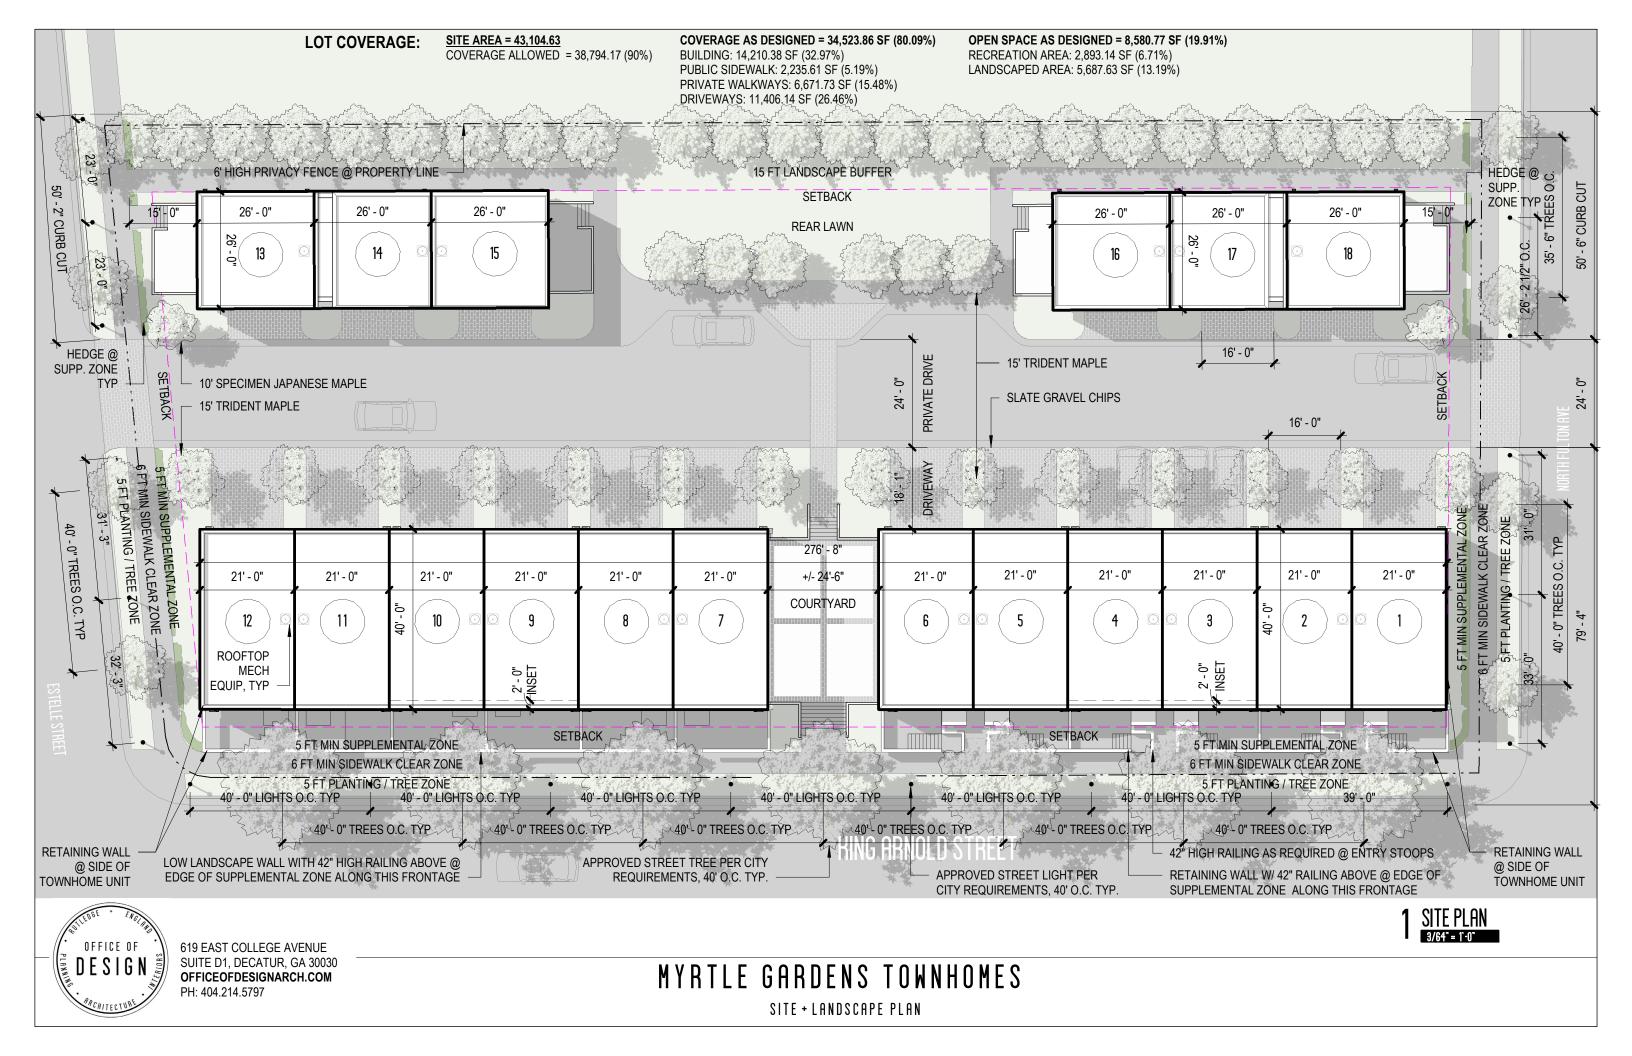






NOTE: SPECIFIED WINDOWS SHALL NOT HAVE GRILLES BETWEEN THE GLASS



1 ELEVATION - KING ARNOLD STREET

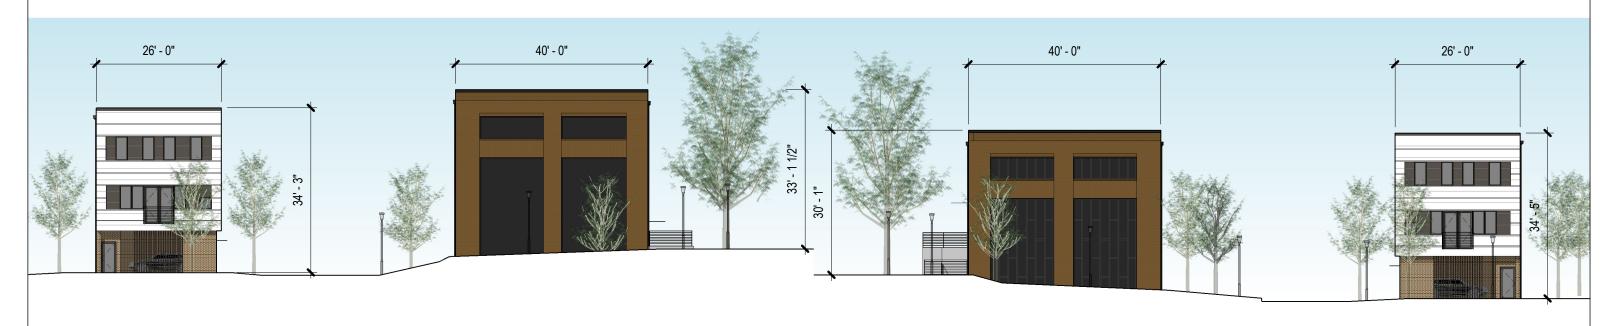

2 ELEVATION - ESTELLE STREET

3 ELEVATION - NORTH FULTON AVE



MYRTLE GARDENS TOWNHOMES

STREET ELEVATIONS



EXTERIOR MATERIAL LEGEND

- BRICK VENEER: SOLDIER CORNICE
 COLOR: CHEROKEE BRICK OLD MISSISSIPPI
 AREA: 680 SF (5.1% OF TOTAL)
- BRICK VENEER
 COLOR: CHEROKEE BRICK OLD MISSISSIPPI
 AREA: 5224 SF (39.5% OF TOTAL)
- BRICK VENEER: STACKED BOND COLOR: CHEROKEE BRICK OLD MISSISSIPPI AREA: 1131 SF (8.6% OF TOTAL)
- 4 FIBER CEMENT SIDING COLOR: SW7076 'CYBERSPACE' AREA: 4222 SF (31.9% OF TOTAL)
- GLAZING
 (INCLUDES DOORS)
 AREA: 1969 SF (14.9% OF TOTAL)

REAR ELEVATION

3/32" = 1'-0"





PRONT ELEVATION

3/32" = 1'-0"

1 END ELEVATION
3/32" = 1'-0"

MYRTLE GARDENS TOWNHOMES

TYPICAL TOWNHOUSE BUILDING – SCHEMATIC ELEVATIONS








MYRTLE GARDENS TOWNHOMES

TRIPLEX BUILDING – SCHEMATIC ELEVATIONS

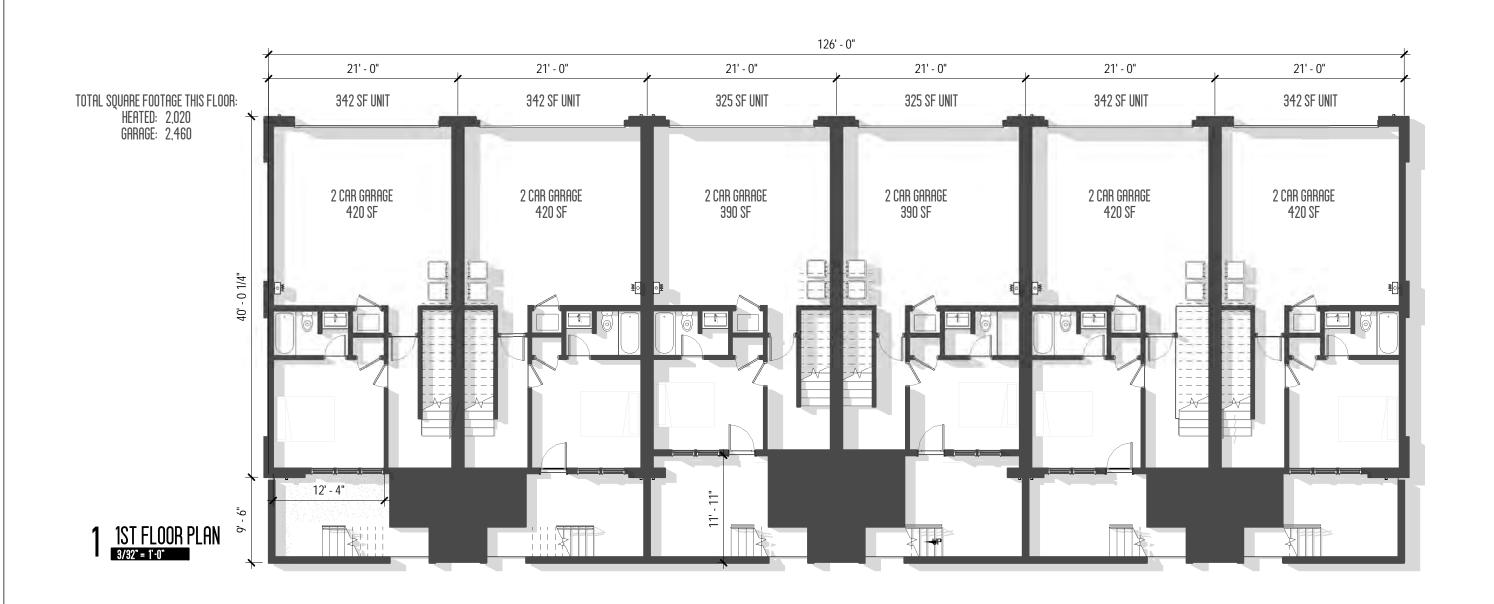




TOTAL SQUARE FOOTAGE THIS FLOOR: 4,479 759 SF UNIT 7 19 SF UNIT 759 SF UNIT 759 SF UNIT 7 19 SF UNIT 759 SF UNIT 40' - 0 1/4" 2 3RD FLOOR PLAN
3/32 = 1.0 TOTAL SQUARE FOOTAGE THIS FLOOR: 4,479 759 SF UNIT 759 SF UNIT 7 19 SF UNIT 7 19 SF UNIT 759 SF UNIT 759 SF UNIT 2ND FLOOR PLAN DESIGN


619 EAST COLLEGE AVENUE SUITE D1, DECATUR, GA 30030 OFFICEOFDESIGNARCH.COM

PH: 404.214.5797


MYRTLE GARDENS TOWNHOMES

TOWNHOUSE BUILDING – SCHEMATIC FLOOR PLANS

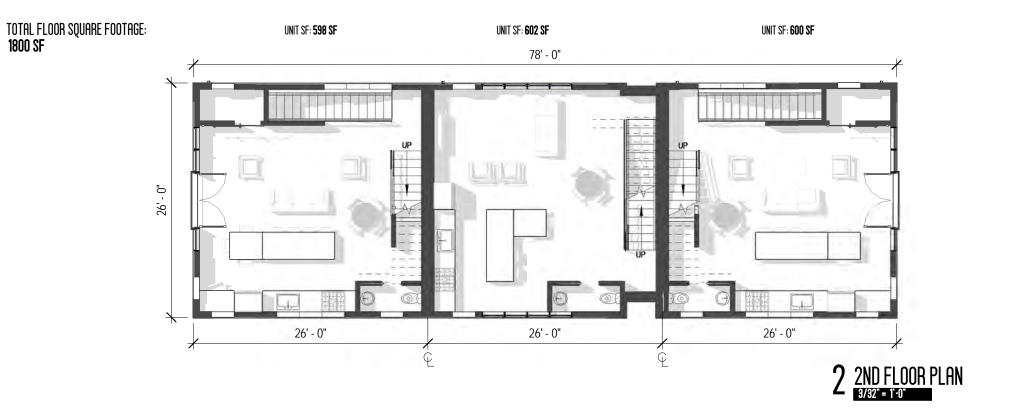


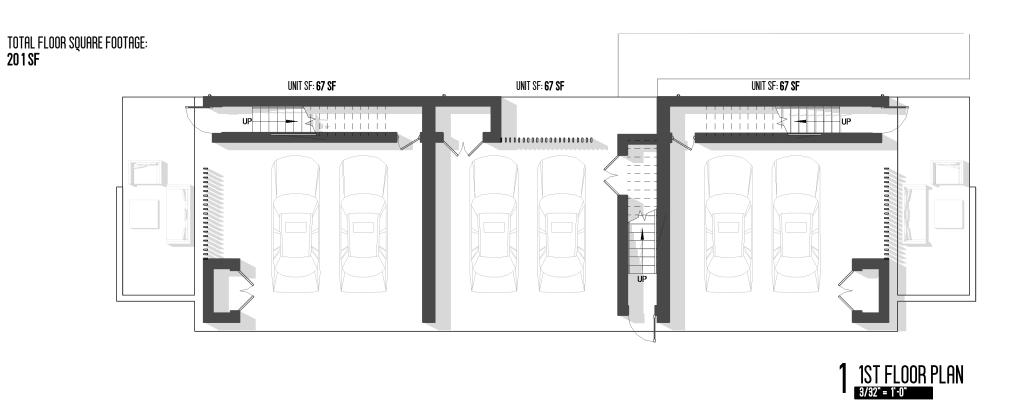



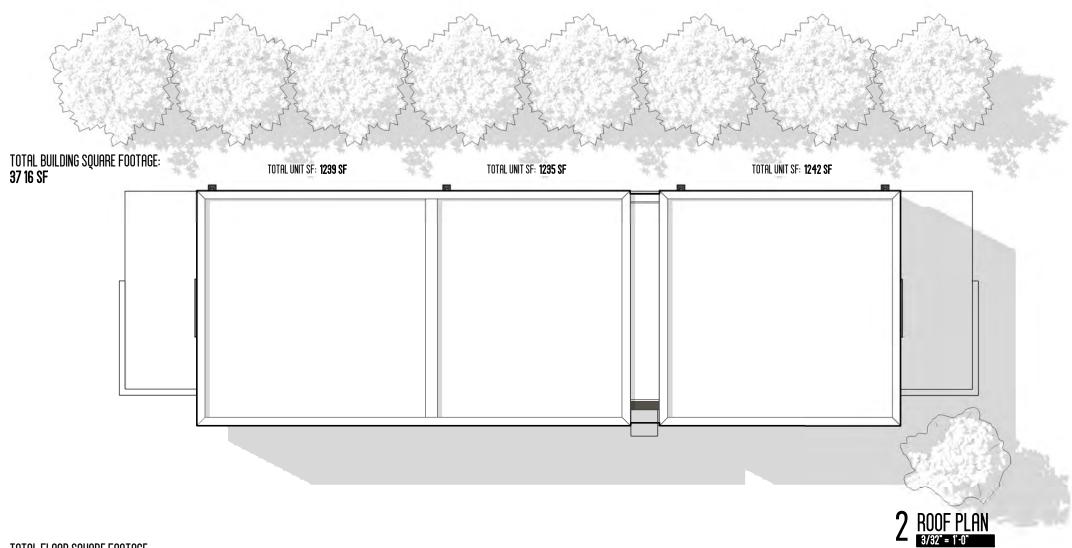

TOTAL FLOOR SQUARE FOOTAGE: **17 15 SF**

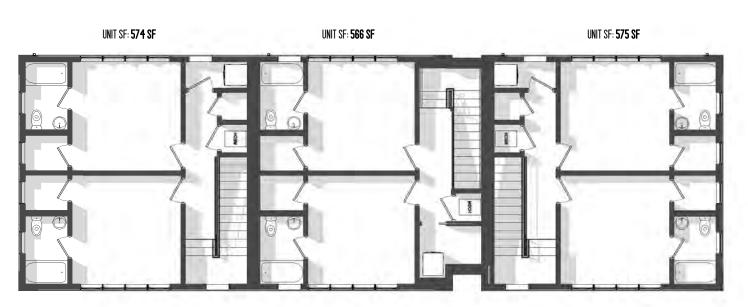

3RD FLOOR PLAN

MYRTLE GARDENS TOWNHOMES

TRIPLEX BUILDING – SCHEMATIC PLANS



DEPARTMENT OF PLANNING AND ZONING PLANNER'S REPORT

Key:

DATE: October 11, 2019

TO: Tonya Hutson

FROM: Michael Smith

RE: Design Review – 801 Virginia Avenue

Compliant:

Not Compliant:

Incomplete:
Not Applicable:

BACKGROUND

The City of Hapeville has received a design review application from Joseph Latimer for the exterior remodel of an existing 4,962 square foot commercial building located at 801 Virginia Avenue. The new exterior will include metal siding, storefront windows, brick, and concrete masonry. The facility will be used as a catering kitchen.

The property is zoned V, Village, is located within the A-D, Arts District overlay, and is subject to the Commercial/Mixed-Use area of the Architectural Design Standards.

CODE

SEC. 81-1-6. COMMERCIAL/MIXED-USE AREA

(a) Site development standards.

- Except where indicated, setbacks shall be established by zoning.
- On corner lots the principal building shall be located adjacent to the street intersection, subject to setback or build-to line requirements of zoning.
- On new buildings in subarea A, where the adjoining buildings were built before 1950, the main facade of the new structure shall align with the average existing building facade line of the two adjoining structures closest to the proposed setback. This will maintain the historic uniform setbacks of subarea A and place buildings close to the public right-of-way, thereby, encouraging pedestrian access.
- Except where a greater height is required by zoning, buildings shall provide a minimum height of 24 feet along the build-to line or front setback, including roof parapet walls. One-story buildings meeting this requirement are permitted.
- ✓ Except where a greater height is required by zoning, the first story finished floor to ceiling slab height shall be a minimum of 12 feet.
- Maximum building heights shall be established by zoning, except that buildings within 150 feet of a neighborhood conservation area and without an intervening street shall be limited to a maximum height of 35 feet, and shall meet the transitional height plane requirements.
- ✓ Space able to be occupied requirements shall be as follows:

One-family attached and detached dwellings and two-family dwellings shall provide first-story occupiable space for a minimum of the first ten feet of depth along the enfronting facade.

Reserved.

- ✓ All other buildings, including parking decks, shall provide first-story occupiable space for a minimum of the first 20 feet of depth along the enfronting facade.
- O Individual front facades of one-family detached dwellings within 15 feet of the front lot line or build-to line shall have no more than two corners, excluding bay windows, porches or stoops.
- ✓ Portions of enfronting facades containing first-story retail or restaurant uses shall be composed as a simple plane with jogs of less than ten feet.
- Buildings along Atlanta Avenue, North Central Avenue, South Central Avenue, Virginia Avenue, Dogwood Drive (except in subarea C), or Sylvan Road shall enfront for a minimum of 80 percent of the width of the front setback or build-to line. In no case shall a break in buildings along said streets exceed 30 feet in width. Enfronting facades along said streets shall also meet the requirement of subsection (g)11. for all uses.
- ✓ Sidewalks shall be located along all public and private streets. Sidewalks shall be of the widths indicated on the "Commercial/Mixed-use Area Sidewalk Table" and shall consist of two areas: a landscape area and a clear area.
 - The landscape area shall be adjacent to the curb and is intended for the placement of trees, street furniture (including utility poles, waste receptacles, fire hydrants, traffic signs and newspaper vending boxes), bus shelters, bicycle racks, public kiosks and similar elements in a manner that does not obstruct pedestrian access or motorist visibility.
 - The landscape area may be primarily paved adjacent to on-street parking and shall be landscaped in all other areas. Street trees shall be planted a maximum of 40 feet on center, spaced equal distance between streetlights, and in line with stripes of parallel parking spaces. All newly planted trees shall be a minimum caliper of two and one-half inches measured 12 inches above ground, shall be limbed up to a minimum height of seven feet and shall have a minimum mature height of 40 feet. Variations to this may be reviewed as approved by the city planning commission.
 - The clear area shall be the portion of the sidewalk reserved for pedestrian passage and unobstructed by permanent objects to a height of eight feet, including, but not limited to, steps and stoops, traffic-control boxes, and utility structures. The sidewalk clear area shall have a consistent cross-slope not exceeding two percent. No awning or canopy shall extend more than five feet over the clear area.
 - Where property abuts a neighborhood conservation area without an intervening street, the sidewalk area within 20 feet of such shall taper when necessary to provide a smooth transition to the existing residential sidewalk. In the event that the abutting residential area has no existing sidewalk the sidewalk shall taper to a width of six feet, measured from the street curb, or as approved by the planning commission.

NOTES:

- The existing structure is nonconforming with Village setback requirements.
- The existing structure does not enfront for the minimum 80% of the width of the front setback.
- The existing sidewalk does not provide the required landscape area and was installed by the City.
- Scope of project does not include changes to the site, building, or sidewalk.

(c) Supplemental area and fence standards.

Supplemental areas in the commercial/mixed-use area shall be limited to the treatments identified in Figure 3 and as otherwise identified in this section.

All first story enfronting commercial uses and all enfronting buildings on Atlanta Avenue, North Central Avenue, South Central Avenue, Virginia Avenue, Dogwood Drive (except in subarea C), or Sylvan Road shall provide the "storefront and awning treatment" identified in Figure 3, and subject to the following additional requirements:

The supplemental area shall be hardscaped.

Temporary or movable fences surrounding outdoor dining are permitted in the supplemental area.

- Services, walls or hedges having the same setback as the adjacent building, with provisions for pedestrian access, are encouraged where a parking lot or other un-built area fronts a required sidewalk.
- All enfronting buildings not along Atlanta Avenue, North Central Avenue, South Central Avenue, Virginia Avenue, Dogwood Drive (except in subarea C), or Sylvan Road shall provide any of the treatments identified in Figure 3.
- O "Common yard, porch and fence, terrace or light court," or "forecourt" treatments identified in Figure 3, the supplemental area shall be landscaped and shall include a minimum of one tree every 50 feet of frontage. See list of allowed trees on in section 93-2-14.
- O For "porch and fence, terrace or light court, stoop-front," or "forecourt" treatments identified in Figure 3.

Fences in the supplemental area are permitted and shall be picket-wood, stone, composite materials or ornamental metal, with the finished side facing the street.

Retaining walls in the supplemental area are permitted and shall not exceed 32 inches in height unless required by topography.

All street-facing walls shall be faced with stone, full-depth brick, or smooth stucco.

- ✓ Chain link fencing is not permitted in areas visible from a public right-of-way.
- Where a development adjoins the neighborhood conservation area, the development shall provide a physical barrier between the two to minimize disruptive light, noise, odor, dust, unsightly appearances and intrusive activity relative to the residential area. A smooth transition to the adjacent neighborhood conservation area shall be ensured by providing:
 - A minimum 20-foot landscaped buffer located within the development site along the boundary with the neighborhood conservation area. Said buffer shall be planted with a minimum of one tree per 40 linear feet. Shrubs, flowers or grasses shall also be provided and maintained to a minimum height of four feet to visually screen new development and provide an attractive boundary that encourages continued investment in adjacent residential zones.
 - A permanent opaque wall between six and eight feet in height and faced in wood, stacked stone, full-depth brick or hard-coat true stucco. Said wall may be located anywhere within the required landscaped buffer.

Where a public or private alley separates the development from a neighborhood conservation area the landscape buffer and permanent opaque wall shall be provided adjacent to the alley.

NOTES:

- A design exception will be required to continue use of existing storefront style and the installation of a landscape buffer instead of required "storefront and awning" style.
- The proposed 15' landscape buffer at the rear of the development is 5' narrower than the 20' required and does not provide a required permanent opaque wall.

(d) Utility standards.

Mechanical features shall be screened from view from any park or along any public right-of-way with planting, walls or fences of equal or greater height. Acceptable nonvegetative materials for screening shall include painted wood or those found in section 93-2-5. Said features are encouraged not to be located in the supplemental area.

- When located on rooftops, mechanical features shall be incorporated in the design of the building and screened with materials similar to the building.
- Skylights are not permitted facing a public right-of-way.
- Street lights shall be provided by the developer in an effort to maintain a safe, walkable and well-lit public area throughout the city; pedestrian scale street lights as approved by the DRC and the department of community services shall be provided by the developer, subject to site plan and design review in new development. This requirement does not apply to projects on lots with less than ten feet of frontage along a public right-of-way.
- Trees shall not be planted on top of storm drains.
- Service areas and dumpsters:

Shall be in the rear or side yard of the development; and

Shall be screened from the public right-of-way to a height of eight feet with an opaque material on all sides, consistent with a primary building material. Acceptable materials for screening shall include painted wood or those found in section 93-2-5.

NOTES:

- The location and screening of mechanical features has not been provided.
- Scope of project does not include changes to utilities.

(e) Parking and traffic standards.

- O Two curb cuts serving two one-way driveways shall be counted as one curb cut.
- O Public or private alleys or driveway providing vehicular access to two or more parcels shall not constitute a curb cut.
- New public streets shall not count as curb cuts.
- ✓ Parcels are permitted a maximum of one driveway curb cut per street frontage. In cases where a property abuts multiple streets the total number of curb cuts or portions thereof may be allocated to a single street.
- O Circular drives are prohibited, with the exception of hotel and hospital uses.
- No curb cuts shall be permitted on North Central Avenue, South Central Avenue, Virginia Avenue or Atlanta Avenue when access can be provided from another street.
- ✓ Driveways shall have widths of:
 - One-family attached dwellings. A minimum of ten feet for a one-way and a maximum of 15 feet for two-way.
 - ✓ All other uses. A maximum of 12 feet for one-way and a maximum of 24 feet for two-way.
- O Carports are only permitted subject to the following requirements:
 - Carports shall be located in the rear or side yard and shall not be visible from a public right-of-way. Carport roofs shall be supported by columns with a minimum width and depth of eight inches.
 - The base of carport columns shall be faced in stacked brick or stacked stone to a minimum height of three feet above grade.
- O Parking is prohibited in the supplemental area and between a building and the adjacent street. This shall not be interpreted as restricting on-street parking.
- ✓ A continuous off right-of-way landscape buffer with a minimum width of ten feet shall be provided between parking and the adjacent sidewalk. This requirement shall apply when existing sidewalks not meeting this requirement are repaired or replaced.

- O Parking decks shall conceal automobiles from visibility and have the appearance of a horizontal storied building on all levels; parking structures must be faced in full-depth brick, stone, cast stone, or precast concrete faced in or having the appearance of brick or stone. Retail or restaurant fronted decks are encouraged.
- O Underground parking is allowed when possible.
- O Drive-through windows and all vehicular queuing, when permitted by zoning, shall be placed to the rear or side of the building facade, shall not be visible from any public right-of-way, and shall not be located within 25 feet of the back of the required sidewalk.
- O Gasoline and service stations shall place all fuel dispensing, service canopies and service entry doors to the rear of the building and away from the public right-of-way. Said facilities and associated queuing shall not be visible from any adjacent street or located within 25 feet of the sidewalk.

NOTES:

(f) Roof and chimney standards.

- O Principal building roofs for one-family detached dwellings shall have a minimum usable life of 30 years, per manufacturer's warranty.
- O Roof shingles shall be slate, cedar, or asphalt.
- Noof tiles shall be clay, terra cotta or concrete.
- Street-facing gutters shall be copper, aluminum or galvanized steel.
- O Downspouts shall match gutters in material and finish.
- Metal flashing, where utilized, shall be copper or factory-finished sheet metal and shall be of a color that blends with other building materials.
- O Chimneys visible from a public right-of-way shall not be faced in wood or fiber cement siding and shall not be a metal or ceramic pipe. Chimneys shall be wrapped in a full-depth brick, stone or masonry finish material.
- O Chimneys located on an exterior building wall shall begin at grade.
- O Buildings with sloped roofs not completely screened from the adjacent street by a parapet shall have a pitch between 4:12 and 12:12. Mansard roofs are prohibited. Pitched-roof materials are limited to roof shingles, natural slate, wood shake, factory-finished sheet metal, and terra cotta tile, unless determined to be historically appropriate by the planning and zoning manager.
- O Roof-mounted lights and flagpoles are prohibited. Roof-mounted satellite dishes or telecommunication devices shall be screened from public view and shall blend with the background of the building as practical.
- O In subarea A roof lines shall appear flat from the adjacent street and roof structures shall be vertically screened by a parapet wall.

NOTES: The structure will re-use the existing metal roof.

(g) Facade and style standards.

✓ Exterior facade materials shall be limited as follows:

Subarea A. Unpainted full-depth brick.

Subarea B. Full-depth brick, cast stone, hard-coat stucco, fiber-cement siding, natural-wood siding or stacked stone.

Subarea C. See neighborhood conservation area.

- Remaining commercial/mixed-use area. Full-depth brick, cast stone, hard-coat stucco, fiber-cement siding, natural-wood siding or stacked stone.
 - *Split-face block.* In addition to the above materials, split-face block may be utilized on exterior facades, but only along a non-enfronting side or rear facade that is not visible from an adjacent street, public park, or plaza.
- ✓ [Materials on enfronting facades.] The materials utilized along an enfronting facade shall be provided for the first 20 feet in length along adjacent non-enfronting facades.
- ✓ [Façade colors, materials.] Facade colors and materials shall be limited to three per facade face.
- Where allowed, the combined enfronting facade area covered with fiber-cement siding and/or natural-wood siding shall not exceed 20 percent of the total enfronting facade area, provided that:

Where a development includes only one building this requirement shall apply to said building. Where a development includes two or more buildings this requirement shall apply to the sum of the total enfronting facade areas. This may result in individual buildings containing front facades

Where allowed, hard-coat stucco shall have a smooth finish. Furthermore, architectural details such as sills, trim, pediments, cornices, railings, door enframements, or similar details shall not be of stucco.

entirely of fiber cement siding and/or natural wood siding.

- In subarea A exterior building colors shall be consistent with the existing historic characteristics of each individual building as a contributing resource from its significant period of design and style. If the building was designed to be of natural or unique brick pattern, it should be returned to this style. All mortar and brick repairs should match the material and hue. Earth hues are suggested for paint, when used on most facades of brick construction, however there may be exceptions. A palette should be established on a building-by-building basis, with a suggested complimentary hue trim color to the base color. It is highly suggested the complete building color palette be limited to three colors for field and trim selections. Two adjacent buildings may use the same color palette only if the field and trim colors are reversed on each of the buildings. No sandblasting or abrasive cleaning methods (including high-pressure washes) shall be used on facades. Final review of selected color, restoration procedures, fixtures, and applications shall be coordinated on a building-by-building analysis through individual design review of visual concepts. The DRC shall make these determinations based on these standards, taking in consideration the style of the building, the nature and marketing of the applying business, the Main Street guidelines, the secretary of the interior's guidelines for renovation, section 93-2-7 et seq. of the zoning ordinance, and the standards for historic preservation.
- ✓ Facade materials shall be combined horizontally, with the heavier below the lighter.
- O Enfronting upper and lowers facades shall be differentiated. Potential ways to achieve this include windows, belt courses, cornice lines or similar architectural details. This is intended to prevent buildings in which individual floors cannot be identified from the building exterior; it should not be interpreted to limit architectural expression.
- Blank, windowless walls are prohibited along enfronting facades, except where a building enfronts multiple streets. In the latter case, it was not historically uncommon for buildings (especially commercial or mixed-use ones) to orient towards the more intensely developed street. As such, along the first story of enfronting mixed-use and commercial facades this requirement may be waived by the building official along streets that are predominantly residential in character when:

The first 20 feet of said facade meets the above requirements, and

The area beyond the first 20 feet is treated with architectural detailing, such as pilasters, false windows, or similar features.

Enfronting upper-story windows are encouraged to be equally sized, vertically oriented, equally spaced and arranged in a grid pattern.

- Foundations shall be constructed as a distinct building element that contrast with facade materials. Foundations that are exposed above the ground, must be parged with cement, stuccoed over or be faced in full-depth brick, natural stone, or cast stone.
- Vending machines, video or other outdoor merchandise displays, mechanical/electrical games, amusement rides, telephones, ice machines, freestanding automated teller machines excluding automated teller machines attached to buildings or integrated into buildings by canopies, and shopping carts shall be placed within the structure of a building and shall be out of view from the public right-ofway.
- Safety pylons, bollards, and trash receptacles in the supplemental area or along an enfronting facade shall be permitted based upon design compatibility with the main facade and neighboring comparable facilities.

NOTES: • A design exception will be required for the use of metal panels as a façade material.

(h) Door and window standards.

- The main entry door to enfronting principal buildings shall face, be visible from, and be accessible from the adjacent public sidewalk.
- The main entry door to all uses shall be linked to the sidewalk via a pedestrian walkway or wheelchair access.
- Sirst-story doors or windows operating on sliders are only permitted when they open directly onto a required sidewalk or supplemental zone.
- Building numbers, at least six inches in height, shall be located above or beside the street-facing pedestrian entrance.
- Window panes serving commercial uses shall be recessed a minimum of three inches and a maximum of eight inches from the adjacent facade.
- Where window lights are utilized they shall be true divided lights, simulated divided lights, or one-over-one lights. Grids between glass are prohibited.
- Where used, window shutters shall match one-half the width of the window opening.
- ✓ Enfronting windows shall be vertically shaped with a height greater than width, including display windows but not transoms.
- Enfronting windows and door glass (except on churches and fire stations) shall utilize clear glass or tinted glass. Tinted glass shall have a transmittance factor of 50 percent or greater and shall have a visible light reflectance factor of ten or less.
- ✓ Painted window or door glass is prohibited.
- All enfronting "storefront and awning" treatments identified in Figure 3, and all enfronting facades along Atlanta Avenue, North Central Avenue, South Central Avenue, Virginia Avenue, Dogwood Drive (except within subarea C), and Sylvan Road shall provide a storefront consisting of:

A nonglass base or knee wall beginning at grade and extending not more than 24 inches above the sidewalk.

A glass display window beginning at the top of the bulkhead or knee wall, to a height not less than ten feet and not more than 12 feet above the adjacent required sidewalk. Such glass shall provide views into display windows having a minimum depth of two and one-half feet and that are accessible from the building interior.

A main entry door remaining unlocked during normal business hours, and having a surface area that is a minimum of 70 percent glass.

A glass transom located above the glass display window having a minimum height of 18 inches and a maximum height of 36 inches.

A minimum of 75 percent of the length of the enfronted portion of the build-to line shall be provided in glass, including glass doors and display windows.

No linear distance of more than ten feet without intervening glass display windows or glass doors.

First-story drop ceilings recessed a minimum of 18 inches from the display window opening.

Awnings projecting from buildings, serving as an entry canopy and/or providing identification to the business, are allowed, provided that:

Awnings shall be at least five feet deep as measured from the building's front facade.

Awnings serving as an entry canopy shall match adjacent business awnings in depth and height.

Valance width and height must align horizontally.

Frame construction on awnings should be square aluminum tubes. Thin, one-and-one-half-inch-diameter round aluminum tube frames are not permitted. It is suggested that Steel Stitch™ brand be used.

Valance on awnings should always be loose as valances should not be rigidly framed.

Approved awnings may be externally lighted with light fixtures in keeping with the style of the building, as approved by the DRC.

Light fixtures in awnings may light the ground surface or storefront below, however, light fixtures may not be visible from the public right-of-way.

Internally, back lit awnings, where the lights actually illuminate the awning fabric, are prohibited. Signs on awning must meet all requirements of the sign ordinance.

• The applicant should provide building numbers adjacent to the front entrance.

RECOMMENDATIONS

Upon review of the information provided by the Applicant, the following items have been found to be missing or deficient and should be addressed by the Applicant and the Design Review Committee:

- 1. A design exception will be required to continue use of existing storefront style and the installation of a landscape buffer instead of the required "storefront and awning" style.
- 2. The proposed 15' landscape buffer at the rear of the development is 5' narrower than the 20' required and does not provide a required permanent opaque wall.
- 3. A design exception will be required for the use of metal panels as a façade material.
- 4. The applicant should provide building numbers adjacent to the front entrance.

Once these items are addressed to the satisfaction of staff and the Design Review Committee, the application is recommended for approval.

CITY OF HAPEVILLE DESIGN REVIEW APPLICATION

SUBMITTAL DATE: 09/17/2019 FOR REVIEW AT 10/16/2019 COMMITTEE MEETING

NOTE:	All applications must be typed authorized representative is require Meeting to answer questions.	d or neatly printed. Applications or an ed to personally appear at the Design Review
	Every attempt will be made to pla month's agenda following the s	neets the third Wednesday of each month. ace your application for review on the next submittal of a completed application with hat may not always be possible. The City cations as deemed necessary.
Applicant:	seph Latimer	_ Contact Number:
Applicants Ad	dress:5200 Buffington Road, At	tlanta, GA 30349
		Zoning Classification: V (Village)
Address of Pro	oposed Work: 801 Virginia Avenu	e, Hapeville, GA 30354
Parcel ID# (INF	FORMATION MUST BE PROVIDED): _	14 009800040265
Property Owne	er: Tara Foods, LLC	Contact Number: _1(404) 427-5080
Project Desc	ription (including occupancy type)	:
Interior and	exterior remodel of existing 4,962	square foot commercial building.
Resurface /	replace existing parking lot area.	The facility will be used as a
Catering Kite	chen occupancy type F1.	
Contractors I	Name: on: _Joseph Latimar Latimer	Contact Number:
hereby make a property. I do lo courate, and I application and esserves that rig further unders ull. I hereby activite the Englis roluntarily comp	pplication to the City of Hapeville, to the hereby swear or affirm that the informati understand that any inaccuracies may any action taken on this application. If to enforce any and all ordinances regatand that it is my/our responsibility to cocknowledge that all requirements of the Cith language and/or this document has beleted this application. I understand that	Design Review Committee for the above referenced on provided here and above is true, complete and be considered just cause for invalidation of this I understand that the City of Hapeville, Georgia, rdless of any action or approval on this application. Inform with all of City of Hapeville's Ordinances in ity of Hapeville shall be adhered to. I can read and een read and explained to me and I have full and it is a felony to make false statements or writings to 20 and I may be prosecuted for violation thereof.
Annlings	Silmat. N	09/17/2019
Applicants S	oignature	Date

Project Class (check one):	
ResidentialCommercial	Mixed-Use Development
Project Type:	
New Commercial Construction	Addition to Existing Commercial Building
Addition to Existing Residential Structure	Accessory Structure
Site Plan, Grading & LandscapingNewNewOther INTERIOR AND EXTERIOR RENOVA	•
Total Square Footage of proposed New Construction:) SF - NO EXPANSION
Total Square Footage of existing building: 4,962 SF	
Estimated Cost of Construction: \$875,000	_
List/Describe Building Materials on the exterior of the exi EXISTING SIDING: STUCCO, METAL SIDING, ALL	
WINDOWS, BRICK AND CONCRETE MASONRY L	JNIT.
EXISTING ROOF SYSTEM : METAL PANEL ROOF	=
EXISTING STAIRS AND RAMP: WOOD AND CON	ICRETE
EXISTING GARAGE DOORS: METAL	
	
List/Describe Building Materials proposed for the exterio SIDING : METAL SIDING, STOREFRONT WINDOW MASONRY UNIT	
ROOF SYSTEM: EXISTING METAL PANEL ROOF	TO REMAIN
STAIRS AND RAMP: BRICK AND CONCRETE WIT	TH METAL RAILINGS
GARAGE DOORS: METAL	

NOTICE

Please be advised that the Community Service Department is here to assist all applicants regarding application procedures, meeting schedules and necessary deadlines. The Community Service Department does NOT make any final decisions for the Design Review Committee, Sign Committee, Planning Commission, Board of Appeals or rezoning request to Mayor and Council.

A complete application must be submitted before the Community Service Department will accept an application and forward the same to the appropriate entity.

Building inspections issued by the City of Hapeville are contracted out to State of Georgia Certified Inspectors. These inspectors make the final decisions regarding building, electrical, plumbing and HVAC work completed in the City of Hapeville. The Hapeville Fire Marshal conducts inspections issued through the Community Services Department as needed. Both the Certified Inspectors and Fire Marshal make the final decisions before Certificates of Occupancy's are issued.

Please be advised that the Community Service Department shall not be responsible for your purchasing materials, equipment, items, signs, etc... before you receive final approval by any entity whose approval is required.

I understand that it is a felony to make false statements or writings to the City of Hapeville, Georgia pursuant to O.C.G.A. 16-10-20 and I may be prosecuted for a violation thereof.

swear or affirm that before receipt of an application, I have received this notice and I read and write the English language or I have had someone read and explain this document to me.

(Please Print & Initial)



DEPARTMENT OF PLANNING AND ZONING

DESIGN REVIEW APPLICATION INSTRUCTIONS AND ACKNOWLEDGEMENT

, the undersigned, agree that with rollowing:	ny signature and submission to	the City of Hapeville, I have done the
Read the City of Hapeville's Arproposed project. The Architectura https://library.municode.com/ga/ha	l Design Guidelines may be fou	nd relevant Code sections for my nd here: nces?nodeId=PTIICOOR CH81ARDEST
Ensured that my proposed proof Ordinances.	oject meets all of the required o	criteria per the City of Hapeville Code
Design Review Committee meeting.		adline for review by Staff prior to the
Identified and explained all def with the requirements set forth in the document in the application.	iciencies or components of the he Code. This explanation shou	proposed project that do not meet ald be submitted as a separate
Understood that any deficience Design Review Committee meeting	ies in the application must be r or the application may not be p	esolved at least 10 days prior to the presented to the DRC for review.
Submitted architectural drawin Community Services or Planning & 2	Coning Department.	
Agreed to submit any required to the Community Services Departm	revisions by the Design Review nent for review prior to request	Committee with updated drawings ing any permits.
Understood that builder must not be issued until a Design Inspect		t the Certificate of Occupancy will tural Design Standards are met.
Latimur 4/17/17		00/47/2040
	7 -	09/17/2019
Printed Name	5ignature	Date

Should you have any questions, please do not hesitate to contact the Community Services Department at 404-669-2120.

Thank you for interest and investment in the City of Hapeville.




COLOR PHOTOS OF EXISTING STRUCTURE







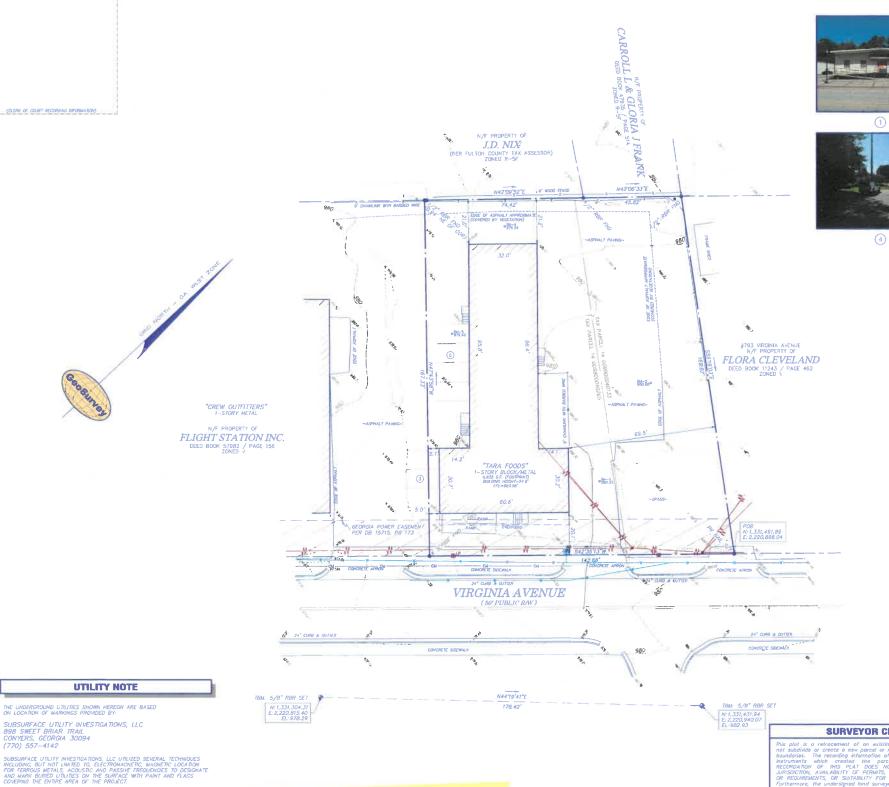

SITE PHOTOGRAPHS















TITLE EXCEPTIONS

12. Easements contained in that Condemnation Order styled Georgia Power Company, Condemnor, v. 0.136 cares, more or less, situate, lying and being in Land Lot 98 of the 14th Land District, (17) of Magaville, Futton County, Georgia and Notand Company, Condemnee, being Case No. E-3940, recorded September 9, 1992, in Deed Book 15715, Pope 173, Futton County, Georgia AFFECTS SITE AS PLOTTED

PROPERTY DESCRIPTION

Said tract of land has and area of 22,060 square feet and contains 0.506 Acres.

TARA FOODS, LLC
DEED BOOK 35305 / PAGE 644
ZONED V

SITE AREA

SURVEYOR CERTIFICATION



VICINITY MAP

GENERAL NOTES

MAXIMUM BUILDING HEIGHT: 2 1/2-STORIES OR 35 FEET

PLEASE NOTE: ZONING AND SETBACKS SHOULD BE CONFIRMED AND VERIFIED BY PLANNING AND ZONING PRIOR TO DESIGN OR CONSTRUCTION ACTIVITIES.

RIGHT-OF-MAY LINES SHOWN ON THIS SURVEY THAT ARE NOT ACTUAL BOUNDARIES OF THE SUBJECT TRACT(S) ARE DEPICTED CRAPHICALLY AND ARE SHOWN APPROXIMATELY FOR INFORMATIONAL PURPOSES ONLY. SAID RIGHT-OF-MAY LINES SHOULD NOT BE UTUZED FOR DESIGN PURPOSES

SURVEY REFERENCES

1> ROSE HEDGE SUBDIVISION PLAT PREPAERD BY LW. & CS. ROBERT CIVIL ENGINEERS RECORDED IN PLAT BOOK 4, PAGE 88.6

LEGEND

STANDARD ABBREVIATIONS

IDARD ABBREVIATIONS

All CONTINUES

BOOK HOLE

BUILDING SETBACK LINE

CURRE INLET

CORNIGATED MALA IPPE

CONTIGATED MALA IPPE

DOUBLE TO PIPE

DOUBLE WING CATCH BASIN

FENCE

FOUNDETER

IJUNCTON BOX

MANNICAL

CONTIGON BOX

MANNICAL

CONTIGON BOX

MANNICAL

FOR TO PIPE

POWER METER

PAR NAL SET

POWER METER

PAR NAL SET

FOR TO PIPE

PAR NAL SET

PAR N

STANDARD SYMBOLS

OVERHEAD TRAFFIC SIGNAL LIGHT

POWER POLE

GUY WRE
POWER LINE
LIGHT FOLE. \boxtimes ELECTRIC TRANSFORMER

WATER VAULT GAS VALVE GAS METER WATER VALVE

REGULAR PARKING SPACE COUNT HANDICAP PARKING SPACE TREE POSITION INDICATOR

SURVEYOR CERTIFICATION



Hem 21 — During the course of the Survey, no above ground visible evidence was observed on the site indicating use as a solid waste dump, senitary londfill, or cemetary/buriol grounds Matters shown on recorded plats are shown on the survey

ALTA CERTIFICATION TABLE "A" NOTES:

Hom 16 — No evidence of current earth moving work, building construction or building odditions was observed at the date of survey.

All man 17 — No evidence was observed indicating changes in street right of way lines.

ompleted or proposed. I — No evidence of wetlands delineation was observed during the course of the

GRAPHIC SCALE

GeoSurvey

Land Surveying . 3D Laser Scanning

Phone: (770) 795-9900 (770) 795-8880		Barnes Mill Road Georgia 30062
rux, (,,o),,bo cooo	Phone: Fax:	(770) 795-9900 (770) 795-8880

ALTA/NSPS LAND TITLE SURVEY

801 Virginia Avenue FOR

Chick-fil-A, Inc. Fidelity National Title Insurance Company

GS JOB NO:	20196205	DRAWING SCAL	LE:	1"=	20'	SURVEY	DATE:	JULY 24,	2019
FIELD WORK:	cc	CITY: FULT	ON	STATE:	GA	No. Date	De	REVISIONS scription	
PROJ MGR:	DLH	COUNTY:	HAPEVI	LLE		1. 8/21/	019 Add	ressed comments	-
REVIEWED:	JRC	LAND LOT:	98						
DWG FILE	20196205.dwg	DISTRICT:	14th				-	_	

THE SURVEYOR MAKES NO GJARANTEES THAT THE UNDERGROUND UTILITIES SHOWN COMPRISE ALL SUCH UTILITIES IN THE AREA, EITHER IN-SERVICE ON ABMINIONED. UNDERGROUND UTILITIES NOT DESERVED OR CLOCKTO.


AND MAY BE FOUND UPON EXCLUSION. THE SURVEYOR FURTHER DOES NOT WARRANT THAT THE UNDERGROUND UTILITIES SHOWN ARE IN THE EXACT LOCATION INDICATED ALTHOUGH THE SURVEYOR DOES CERTIFY THAT THEY ARE LOCATED AS DECREATED AS DESERVED THE SURVEYOR DOES CERTIFY THAT THEY ARE LOCATED AS DECREATED AS DESERVED THE SURVEYOR DOES CERTIFY THAT THEY ARE LOCATED AS DECREATED AS DESERVED AS DESERVED AS DESERVED AS DESERVED AS DESERVED AS DESERVED. LEUPL PENCEIPTION INFORMATION REGARDING MATERIAL AND SIZE OF UTILITIES IS BASED ON RECORDS ACQUIRED FROM THE UTILITY OWNERS

IF YOU DIG

Know what's below. Call before you dig. Dial 811 Or Call 800-282-7411

CLOSURE STATEMENT

THIS PLAT HAS BEEN CALCULATED FOR CLOSURE AND WAS FOUND TO BE ACCURATE WITHIN ONE FOOT IN 147.851 FEET. all INIT.

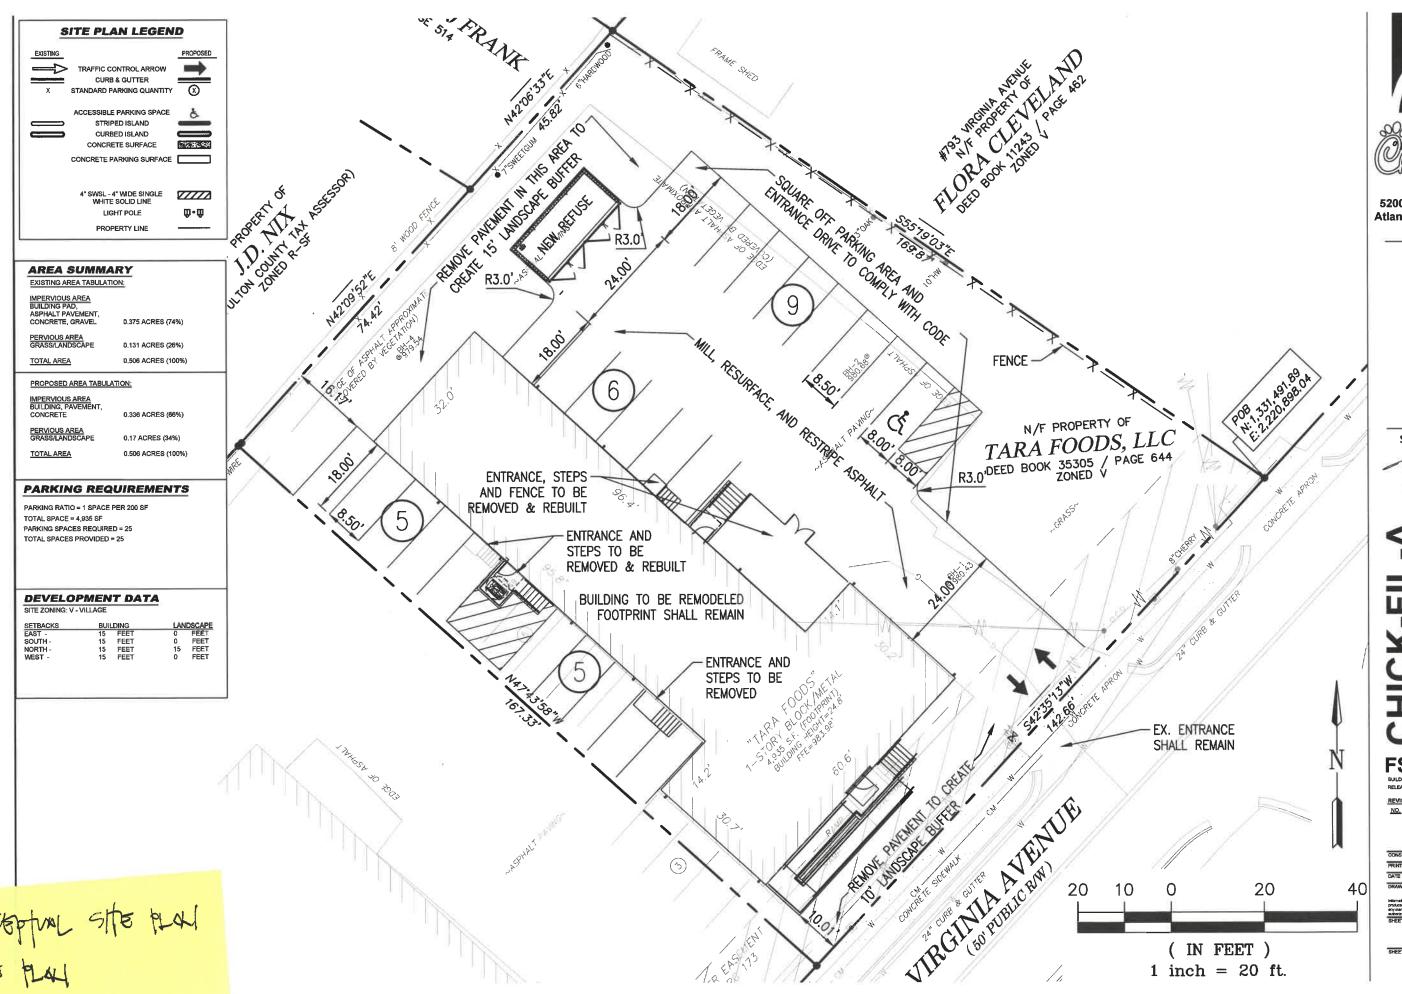





Chick-fil-A 5200 Buffington Road Atlanta, Georgia 30349-2998







Hapeville RPK 801 Virginia Ave. Hapeville, GA 30354

FSR#70053

REVISION SCHEDULE
NO. DATE DESCRIPTION

CONICH TANT DOO ISCT

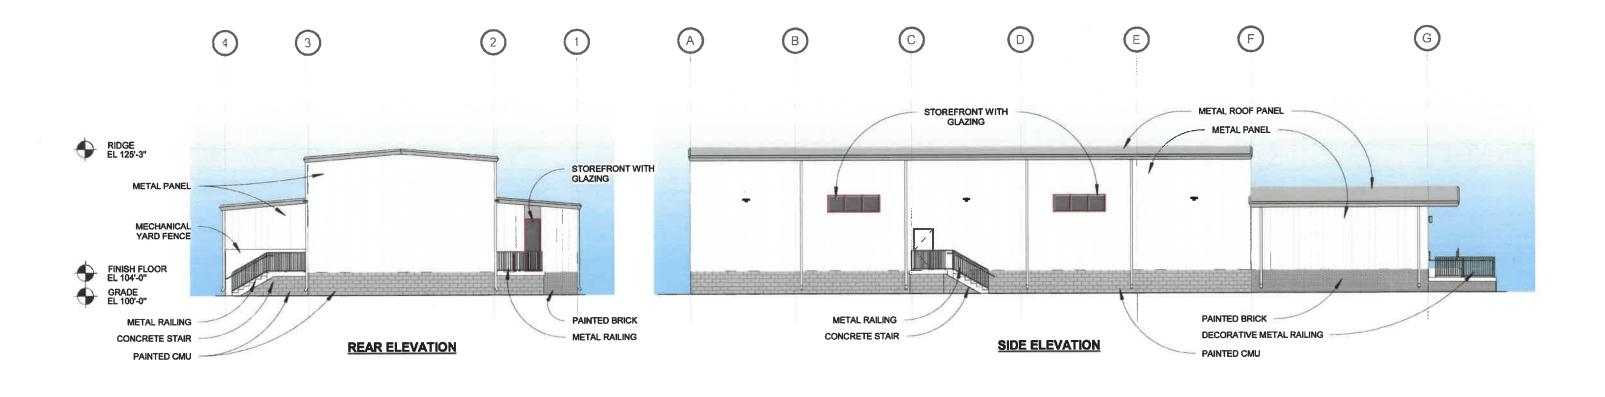

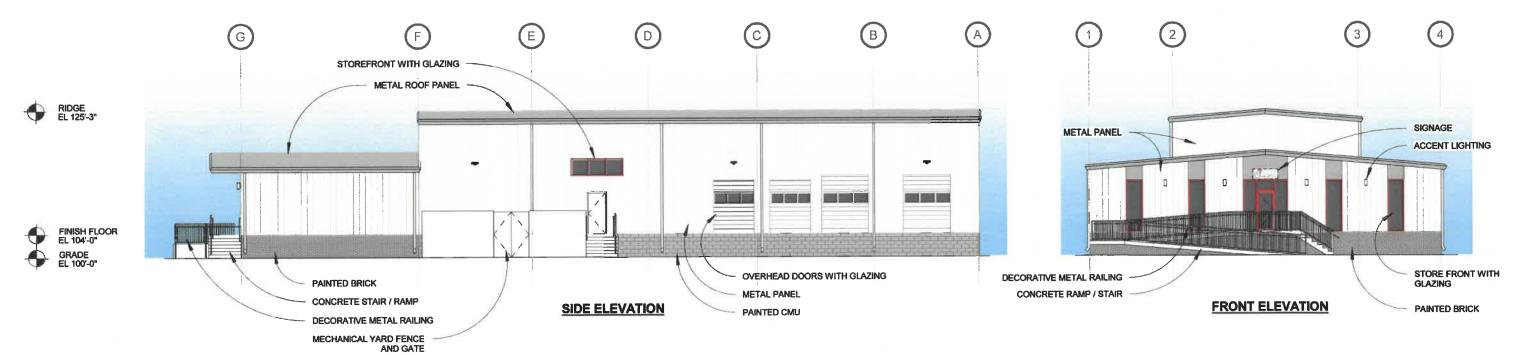

SELSER SCHAEFER ARCHITECTS
© 2019



BUILDING FLEVATIONS
COLOR RENDEPHICAS


SCALE: 1/16" = 1'-0"

0 8 16 33

EXTERIOR ELEVATIONS


CHICK-FIL-A, INC HAPEVILLE REMOTE PREPARATION KITCHEN

12 SEPTEMBER 2019 801 VIRGINIA AVENUE, HAPEVILLE, GEORGIA 30354

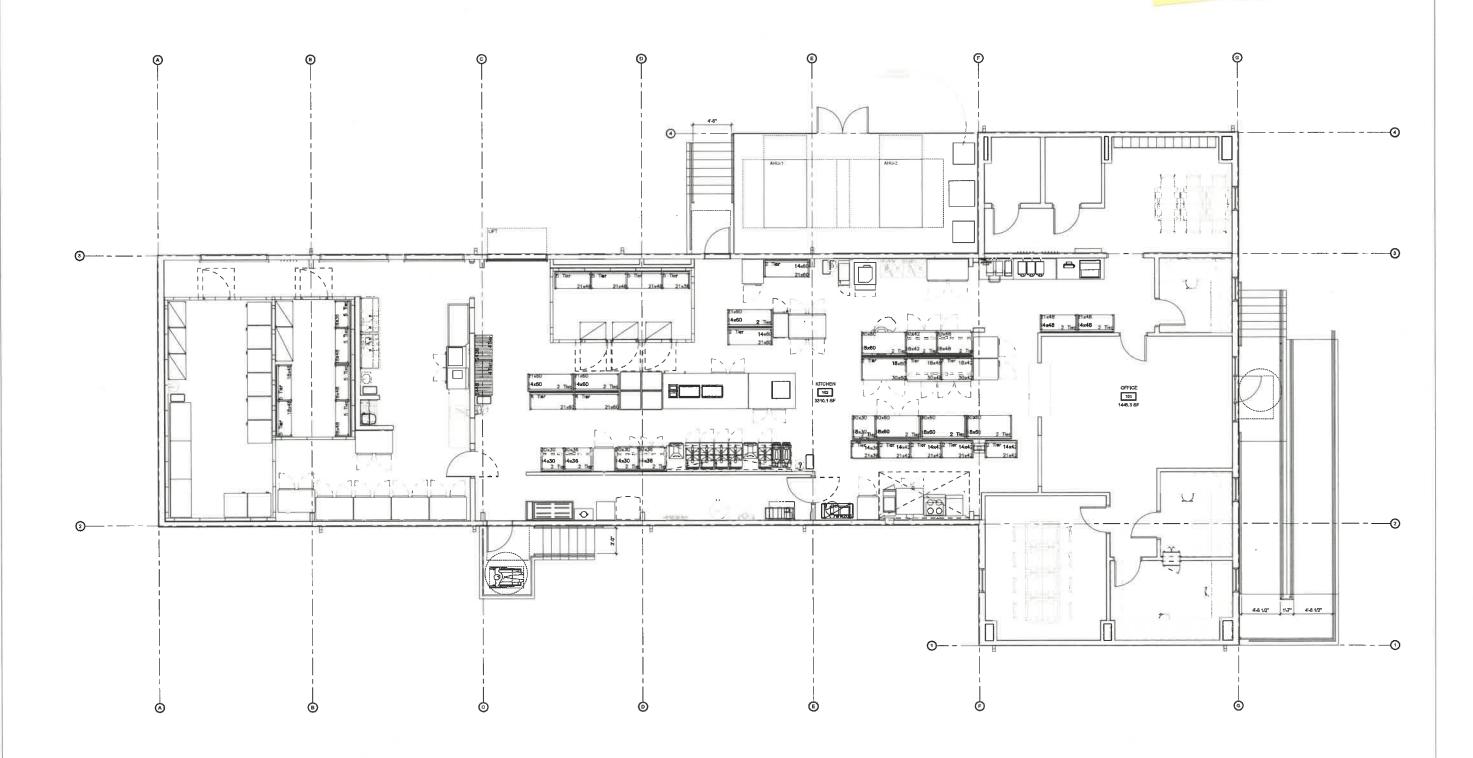






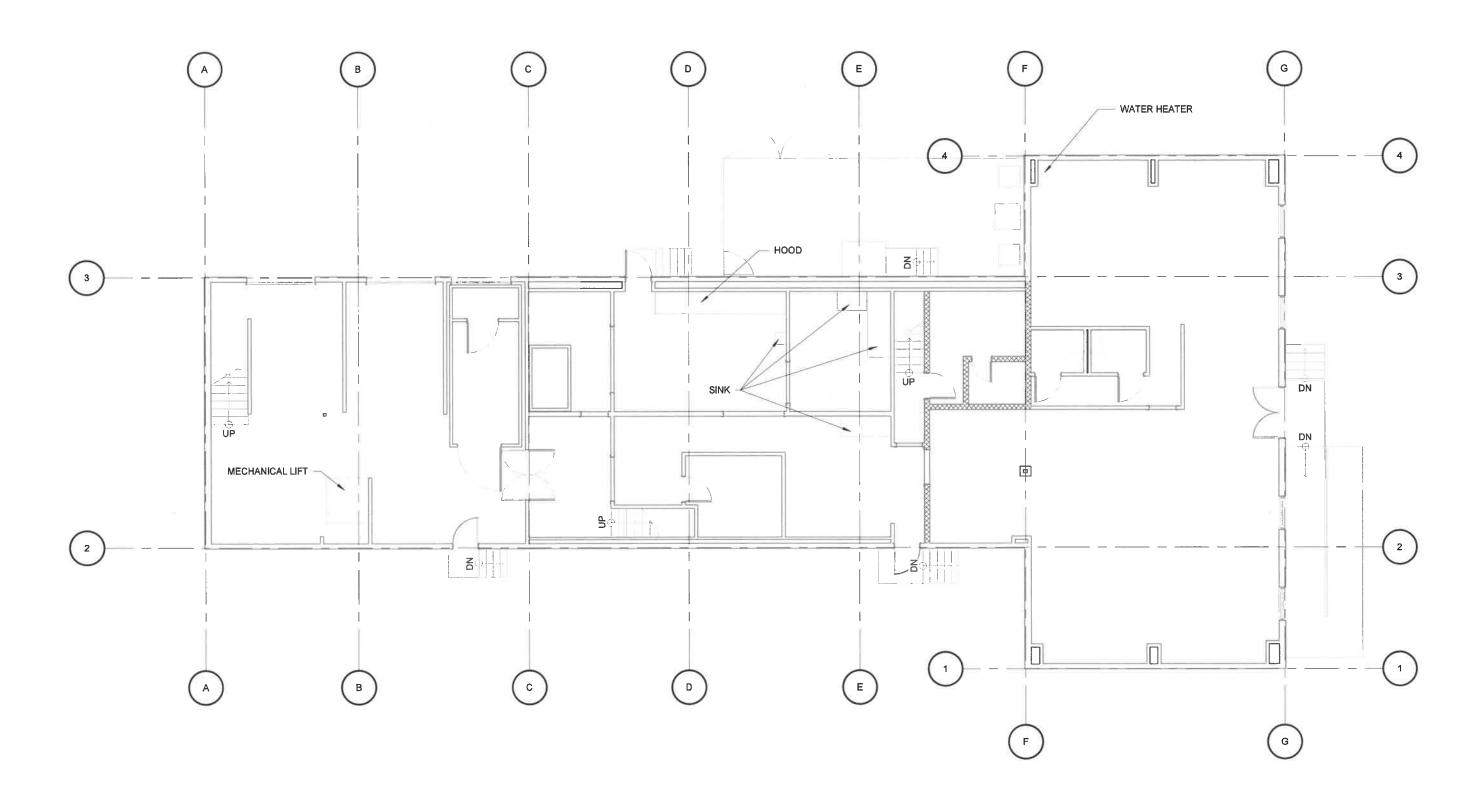

EXISTING FIRST LEVEL FLOOR PLAN

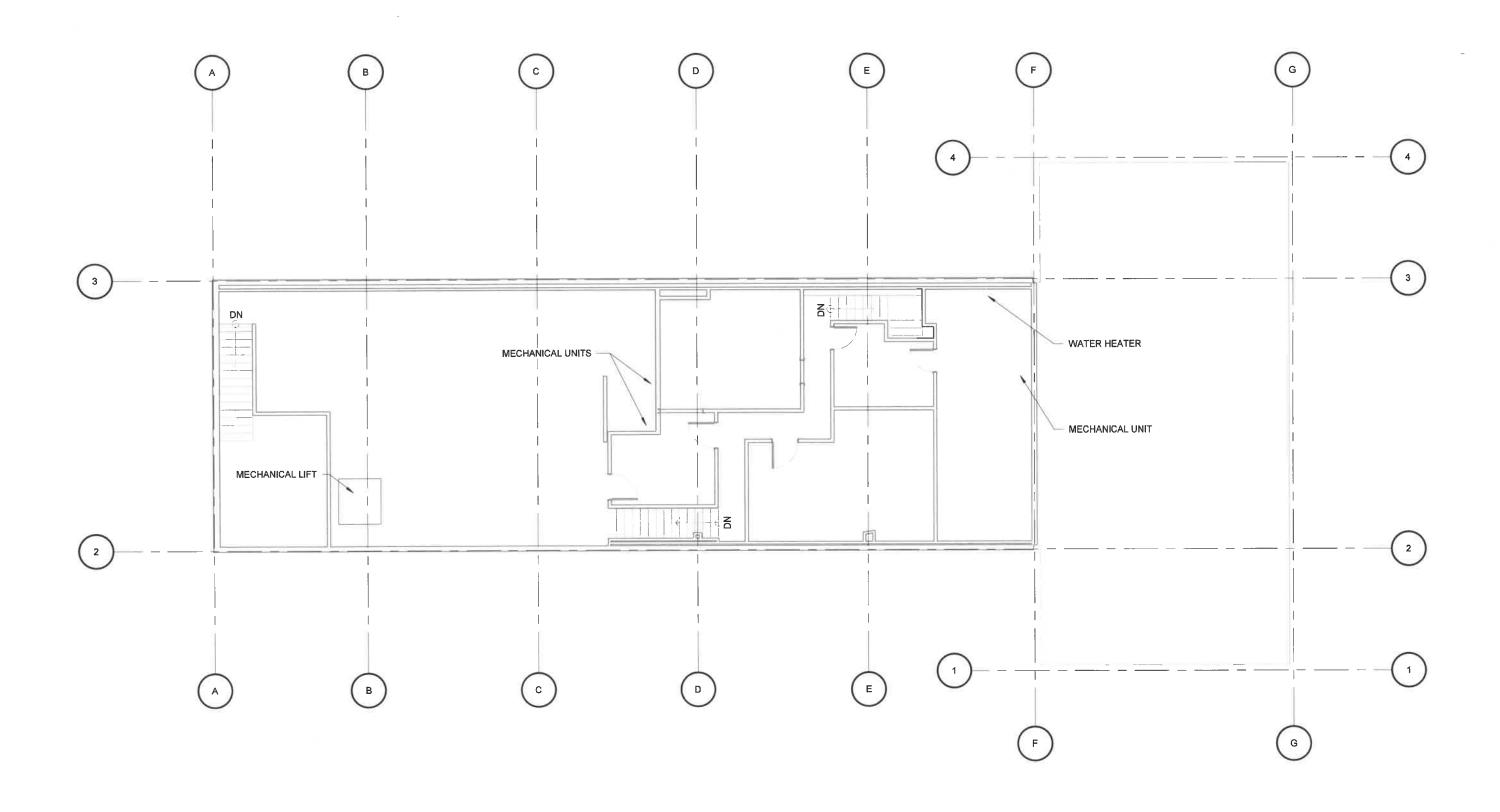

EXISTING SECOND LEVEL FLOOR PLAN



DEPARTMENT OF PLANNING AND ZONING PLANNER'S REPORT

DATE: October 11, 2019
TO: Tonya Hutson
FROM: Michael Smith

RE: Design Review – Porsche Avenue – Auto Service Center

BACKGROUND

The City of Hapeville has received a design review application from Steven Ellis on behalf of PRO Building Systems Inc, to develop a specialty auto service center and repair facility as a component of Porsche Cars of North America's corporate campus concept on Porsche Avenue (Parcel ID 14 0096 LL0593). The lot is currently partially paved but is otherwise undeveloped. The site area under consideration is 2.5 acres. The facility is shown as a 20' high building surrounded by parking as well as one accessory structure. The size of the building is varyingly provided as either 17,600 or 20,815 square feet on the application; however, the applicant has indicated that the correct number is the larger of the two.

The property is zoned B-P, Business Park. The B-P zoning district requires new construction to reflect the designs of buildings immediately adjacent to the zone. As such, the architectural design guidelines are superseded by the requirements of zoning and thus do not apply. The role of the Design Review Committee is to ensure designs are consistent with the requirements of the B-P zoning and to approve the landscape plan.

The applicant intends to apply for three Variances from the Board of Appeals:

- 1. Increase the maximum parking above 110% of the minimum parking.
- 2. Reduce the number of required compact parking spaces.
- 3. Increase the maximum width of the new driveway.

CODE

ARTICLE 18. - B-P ZONE (BUSINESS PARK)

Sec. 93-18-1. - Intent.

- (a) The purpose of this district is to encourage the development of a high-quality community of businesses, office services and recreation uses to promote economic development for the city by fostering the creation of significant employment centers.
- (b) In order to further the achievement of this purpose, applicants for development within the B-P (business park) district shall submit proposed site development plans for review and approval in accordance with the provisions of section 93-2-16.

(c) To create continuity for the business park aesthetic, buildings and sites must reflect buildings immediately adjacent to the zone.



Adjacent Kimpton Overland Hotel, Entrance.



Adjacent Kimpton Overland Hotel, facing proposed development.



Porsche North America Headquarters, Atlanta, adjacent to B-P district, front façade.



Porsche North America Headquarters, Atlanta, adjacent to B-P district, side/rear.

Sec. 93-18-5. - Site development and improvement standards.

In order to establish and maintain the B-P (Business Park) district as a quality area which will preserve the investments of all landowners and developers, as well as the tax base of the city, all construction and development within the B-P district shall comply with the following standards:

- (3) Buildings.
 - a. Exterior wall materials shall be one or more of the following:
 - Hard-coat stucco;
 - Stone with either a weathered face or a polished, fluted or broken face. No quarry-faced stone shall be used except in retaining walls;
 - 3. Fiber-cement siding;
 - 4. Glass;
 - 5. Metal and metal panel; or
 - 6. Concrete masonry.
 - i. Units shall be those generally described by the National Concrete Masonry Association as "customized architectural concrete masonry units" or shall be broken faced brick-type units with marble aggregate. There shall be no exposed concrete block on the exterior of any building visible from any public right-of-way. Any concrete masonry units that have gray cement color visible from any public right-of-way shall be coated with a coating approved by the design review committee.
 - ii. Concrete may be poured in-place, tilt-up or precast. Poured in-place and tilt-up walls may be exposed or have a finish of stone, a texture, metal panels or screening, or a coating. Textured finishes shall be coated. Coating shall be an approved cementitious of any epoxy type with a life expectancy of at least ten years.
 - b. Other exterior wall materials may be used only with the prior approval of the design review committee. Approval or disapproval will be judged on the appropriateness of the materials when considered in context with other buildings in the same business park.
 - c. Outside storage of materials is prohibited.
 - d. Roof-mounted equipment shall be located and/or screened to minimize visibility from streets or surrounding buildings.
- (4) Landscaping. Landscaping design standards shall be established during design review. Approval or disapproval will be judged on the appropriateness of the materials when considered in context of the location of the landscaping, the visibility of the landscaping to the general public on the nearest public right-of-way and in context with other buildings in the same business park.

RECOMMENDATION

The proposed use of glass and metal wall panels for the exterior façade is compliant with B-P zoning and is consistent with adjacent buildings and the Porsche North America corporate campus concept. Staff recommends the installation of a sidewalk to provide continuity with existing sidewalks on adjacent Porsche properties.

The DRC must approve of the landscape plan. The City is currently preparing a new Tree Ordinance, which includes new regulations for landscaping in off-street parking areas. Staff recommends the landscape plan be modified to comply with these new requirements, which are provided below:

- (a) Parking Lot Trees shall be provided in landscape islands in parking areas proposing 5 or more spaces. Parking areas with fewer than 5 spaces and multi-level parking decks are exempt.
- (b) A sufficient number of 3" Caliper (minimum) Trees must be planted in interior portions of parking lots so that no parking space is more than fifty (50) feet from a parking lot Tree. Show a fifty-foot radius dashed circle for each Parking Lot Tree on Tree Replacement Plan to verify graphically. Up to 20% of Parking Lot Trees may be planted along the perimeter of the parking lot. Landscaped islands shall terminate each row of parking and all landscaped islands planted with Trees shall provide a minimum of 200 sf per Tree. Light poles are not permitted in parking lot islands, peninsulas and medians unless they are a minimum of 20' from any planted Tree.

Should the above requirements be addressed to the satisfaction of the DRC, staff recommends approval.

Please note that signs are governed by the City's sign ordinance are will require separate permits.

CITY OF HAPEVILLE DESIGN REVIEW APPLICATION

SUBMITTAL	. DATE :September 18, 2019	4(47-1-1)	
NOTE:	All applications must be typed authorized representative is required Meeting to answer questions.		
	The Design Review Committee mee Every attempt will be made to place month's agenda following the sub supporting documents; however, that reserves the right to schedule applicat	e your application for revie omittal of a completed a t may not always be possi	w on the next pplication with
Applicant: Ste	even Ellis, PRO Building Systems, Inc.	Contact Number:	
Applicants Ad	Idress: c/o The Galloway Law Group, LLC,	3500 Lenox Road NE, Suite 76	0, Atlanta, GA 30326
E-Mail Addres	s: _laurel@glawgp.com	Zoning Classification:	B-P
Address of Pro	oposed Work: Porsche Avenue		
Parcel ID# (INF	FORMATION MUST BE PROVIDED): 14 0	096 LL0593	
Property Owne	er: Porsche Cars North America, Inc.	Contact Number: <u>(770)</u> 290-3	3833
Project Desc	ription (including occupancy type):		
The Applicant p	proposes a state of the art automobile servi	ce center and repair facility on	the site. The
facility will be a	associated with Porsche's adjacent office he	adquarters, which is greater that	an 200,000
square feet in s	size, and is part of Porsche's corporate cam	pus concept.	
Contractors N	Name: PRO Building Systems	Contact Number: _770.	455.1791
	on: Steven T. Ellis	Contact Number:	
roperty. I do I ccurate, and I pplication and eserves that rig further unders ull. I hereby ac rite the Englis oluntarily comp ne City of Pape	application to the City of Hapeville, to the Deshereby swear or affirm that the information understand that any inaccuracies may be any action taken on this application. It is got to enforce any and all ordinances regardle stand that it is my/our responsibility to confocknowledge that all requirements of the City is language and/or this document has been pleted this application. I understand that it is eville, Georgia pursuant to O.C.G.A. 16-10-20 and Signature	provided here and above is true considered just cause for invalunderstand that the City of Haless of any action or approval on orm with all of City of Hapeville of Hapeville shall be adhered to read and explained to me and a felony to make false statement	ne, complete and validation of this peville, Georgia, this application. 's Ordinances in o. I can read and d I have full and nts or writings to ation thereof.

Project Class (check on	e):	
Residential	XCommercial	Mixed-Use Development
Project Type:		
XNew Commercial Co	onstruction	Addition to Existing Commercial Building
Addition to Existing R	Residential Structure	Accessory Structure
Site Plan, Grading &	Landscaping	New Single Family Residential Construction
Other		
Total Square Footage of pro	posed New Construction	1: 20,815 SF building
Total Square Footage of exi	sting building:n/a	
Estimated Cost of Construct	tion: \$3.5 MIL	
List/Describe Building Mater There is no existing structure a		e existing structure:
List/Describe Building Mater	ials <u>proposed</u> for the ex	terior facade of the new structure:
Glass, Perforated Metal Wall P	anels, Architectural Ribbed	Metal Wall Panels
	•	

NOTICE

Please be advised that the Community Service Department is here to assist all applicants regarding application procedures, meeting schedules and necessary deadlines. The Community Service Department does **NOT** make any final decisions for the Design Review Committee, Sign Committee, Planning Commission, Board of Appeals or rezoning request to Mayor and Council.

A complete application must be submitted before the Community Service Department will accept an application and forward the same to the appropriate entity.

Building inspections issued by the City of Hapeville are contracted out to State of Georgia Certified Inspectors. These inspectors make the final decisions regarding building, electrical, plumbing and HVAC work completed in the City of Hapeville. The Hapeville Fire Marshal conducts inspections issued through the Community Services Department as needed. Both the Certified Inspectors and Fire Marshal make the final decisions before Certificates of Occupancy's are issued.

Please be advised that the Community Service Department shall not be responsible for your purchasing materials, equipment, items, signs, etc... before you receive final approval by any entity whose approval is required.

I understand that it is a felony to make false statements or writings to the City of Hapeville, Georgia pursuant to O.C.G.A. 16-10-20 and I may be prosecuted for a violation thereof.

(Please Print & Initial)

I STEVENT ELUC swear or affirm that before receipt of an application, I have received this notice and I read and write the English language or I have had someone read and explain this document to me.



DEPARTMENT OF PLANNING AND ZONING

DESIGN REVIEW APPLICATION INSTRUCTIONS AND ACKNOWLEDGEMENT

I, the undersigned, agree that with my signature and submission to the City of Hapeville, I have done the following:
Read the City of Hapeville's Architectural Design Guidelines and relevant Code sections for my proposed project. The Architectural Design Guidelines may be found here: https://library.municode.com/ga/hapeville/codes/code of ordinances?nodeld=PTIICOOR CH81ARDEST
Ensured that my proposed project meets all of the required criteria per the City of Hapeville Code of Ordinances.
Submitted my application materials in full by the published deadline for review by Staff prior to the Design Review Committee meeting.
Identified and explained all deficiencies or components of the proposed project that do not meet with the requirements set forth in the Code. This explanation should be submitted as a separate document in the application.
Understood that any deficiencies in the application must be resolved at least 10 days prior to the Design Review Committee meeting or the application may not be presented to the DRC for review.
Submitted architectural drawings and details for all projects unless allowed in writing by the Community Services or Planning & Zoning Department.
Agreed to submit any required revisions by the Design Review Committee with updated drawings
to the Community Services Department for review prior to requesting any permits.
Steven Ellis, PRO Building Systems, Inc.
Printed Name Signature Date
Should you have any questions, please do not hesitate to contact the Community Services Department at 404-669-2120.

Thank you for interest and investment in the City of Hapeville.

Porsche Service Center Lease Area

All that tract or parcel of land lying and being in Land Lot 96 of the 14th District, City of Hapeville, Fulton County, Georgia and being more particularly described as follows:

Beginning at an iron pin set on the southwesterly right-of-way of Porsche Avenue (formerly known as Henry Ford II Avenue and having a varied right-of-way) located 950.91 feet as measured northwesterly along said right-of-way from its intersection with the westerly right-of-way of Porsche Drive (having a varied right-of-way); Thence leaving said right-of-way and running South 35 degrees 19 minutes 11 seconds West a distance of 402.62 feet to an iron pin set; Thence running North 89 degrees 35 minutes 16 seconds West a distance of 191.68 feet to an iron pin set; Thence running North 00 degrees 24 minutes 44 seconds East a distance of 140.11 feet to nail found; Thence running North 35 degrees 19 minutes 11 seconds East a distance of 379.13 feet to nail found; Thence running North 32 degrees 25 minutes 35 seconds East a distance of 22.59 feet to nail found on the southwesterly right-of-way of Porsche Avenue; Thence running along said right-of-way South 53 degrees 39 minutes 04 seconds East a distance of 238.55 feet to and iron pin set and The Point of Beginning;

Said tract contains 2.50 acres (108,900 square feet.

SITE IMAGES

DESIGN REVIEW COMMITTEE APPLICATION CITY OF HAPEVILLE, GEORGIA




SITE IMAGES

DESIGN REVIEW COMMITTEE APPLICATION CITY OF HAPEVILLE, GEORGIA



SITE IMAGES DESIGN REVIEW COMMITTEE APPLICATION CITY OF HAPEVILLE, GEORGIA



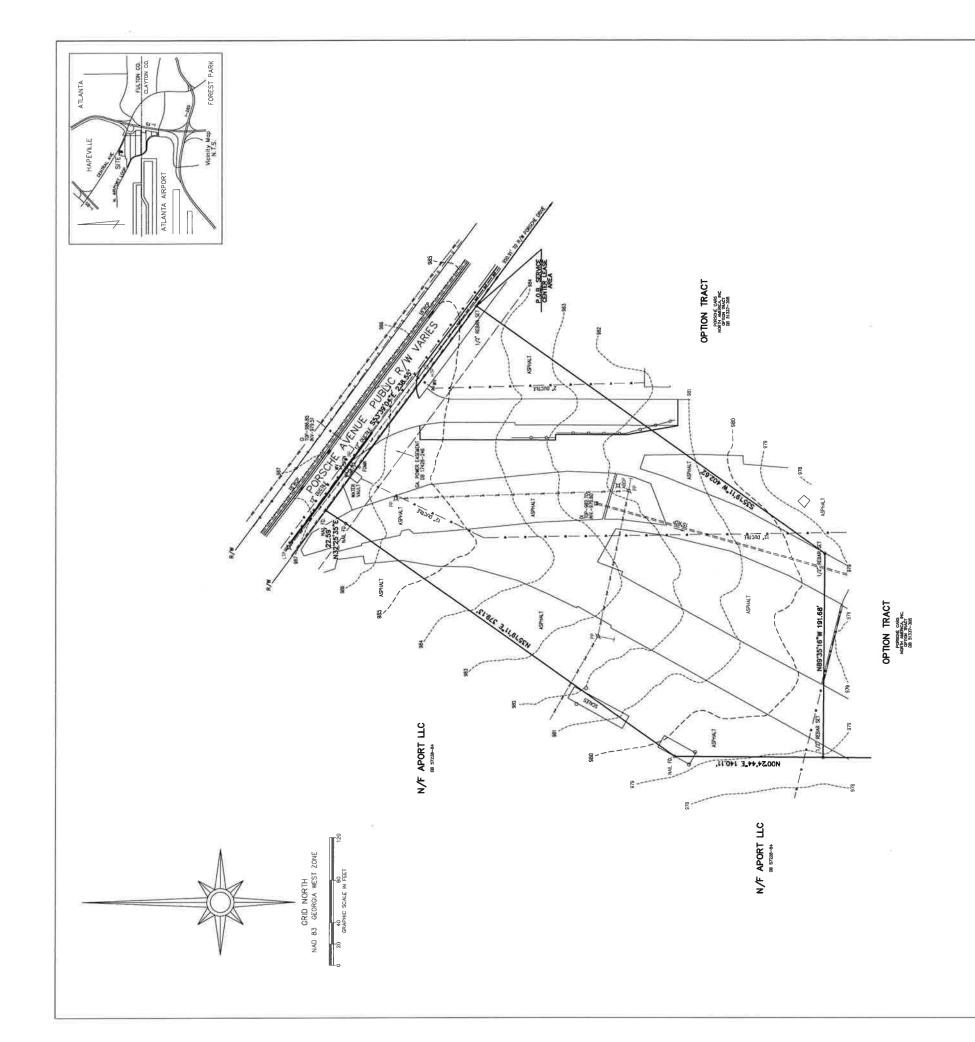

108,900 SQ.FT. 2.50 ACRES SERVICE CENTER LEASE AREA:

Equipment used:

Angulor & Limers: Sokkin IX Robotic Total Station

Angulor & Limers: Sokkin IX Robotic Total Station

Reference: Deed Book 51337 Page 335

The field data upon which this path is bosed has a cleaure pre-Bion on angulor error of each may be a made point and was adjusted using the Least Squares Method:

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Bearings are referenced to Grid North, Georgia State Plane

Coordinate System, West Sone.

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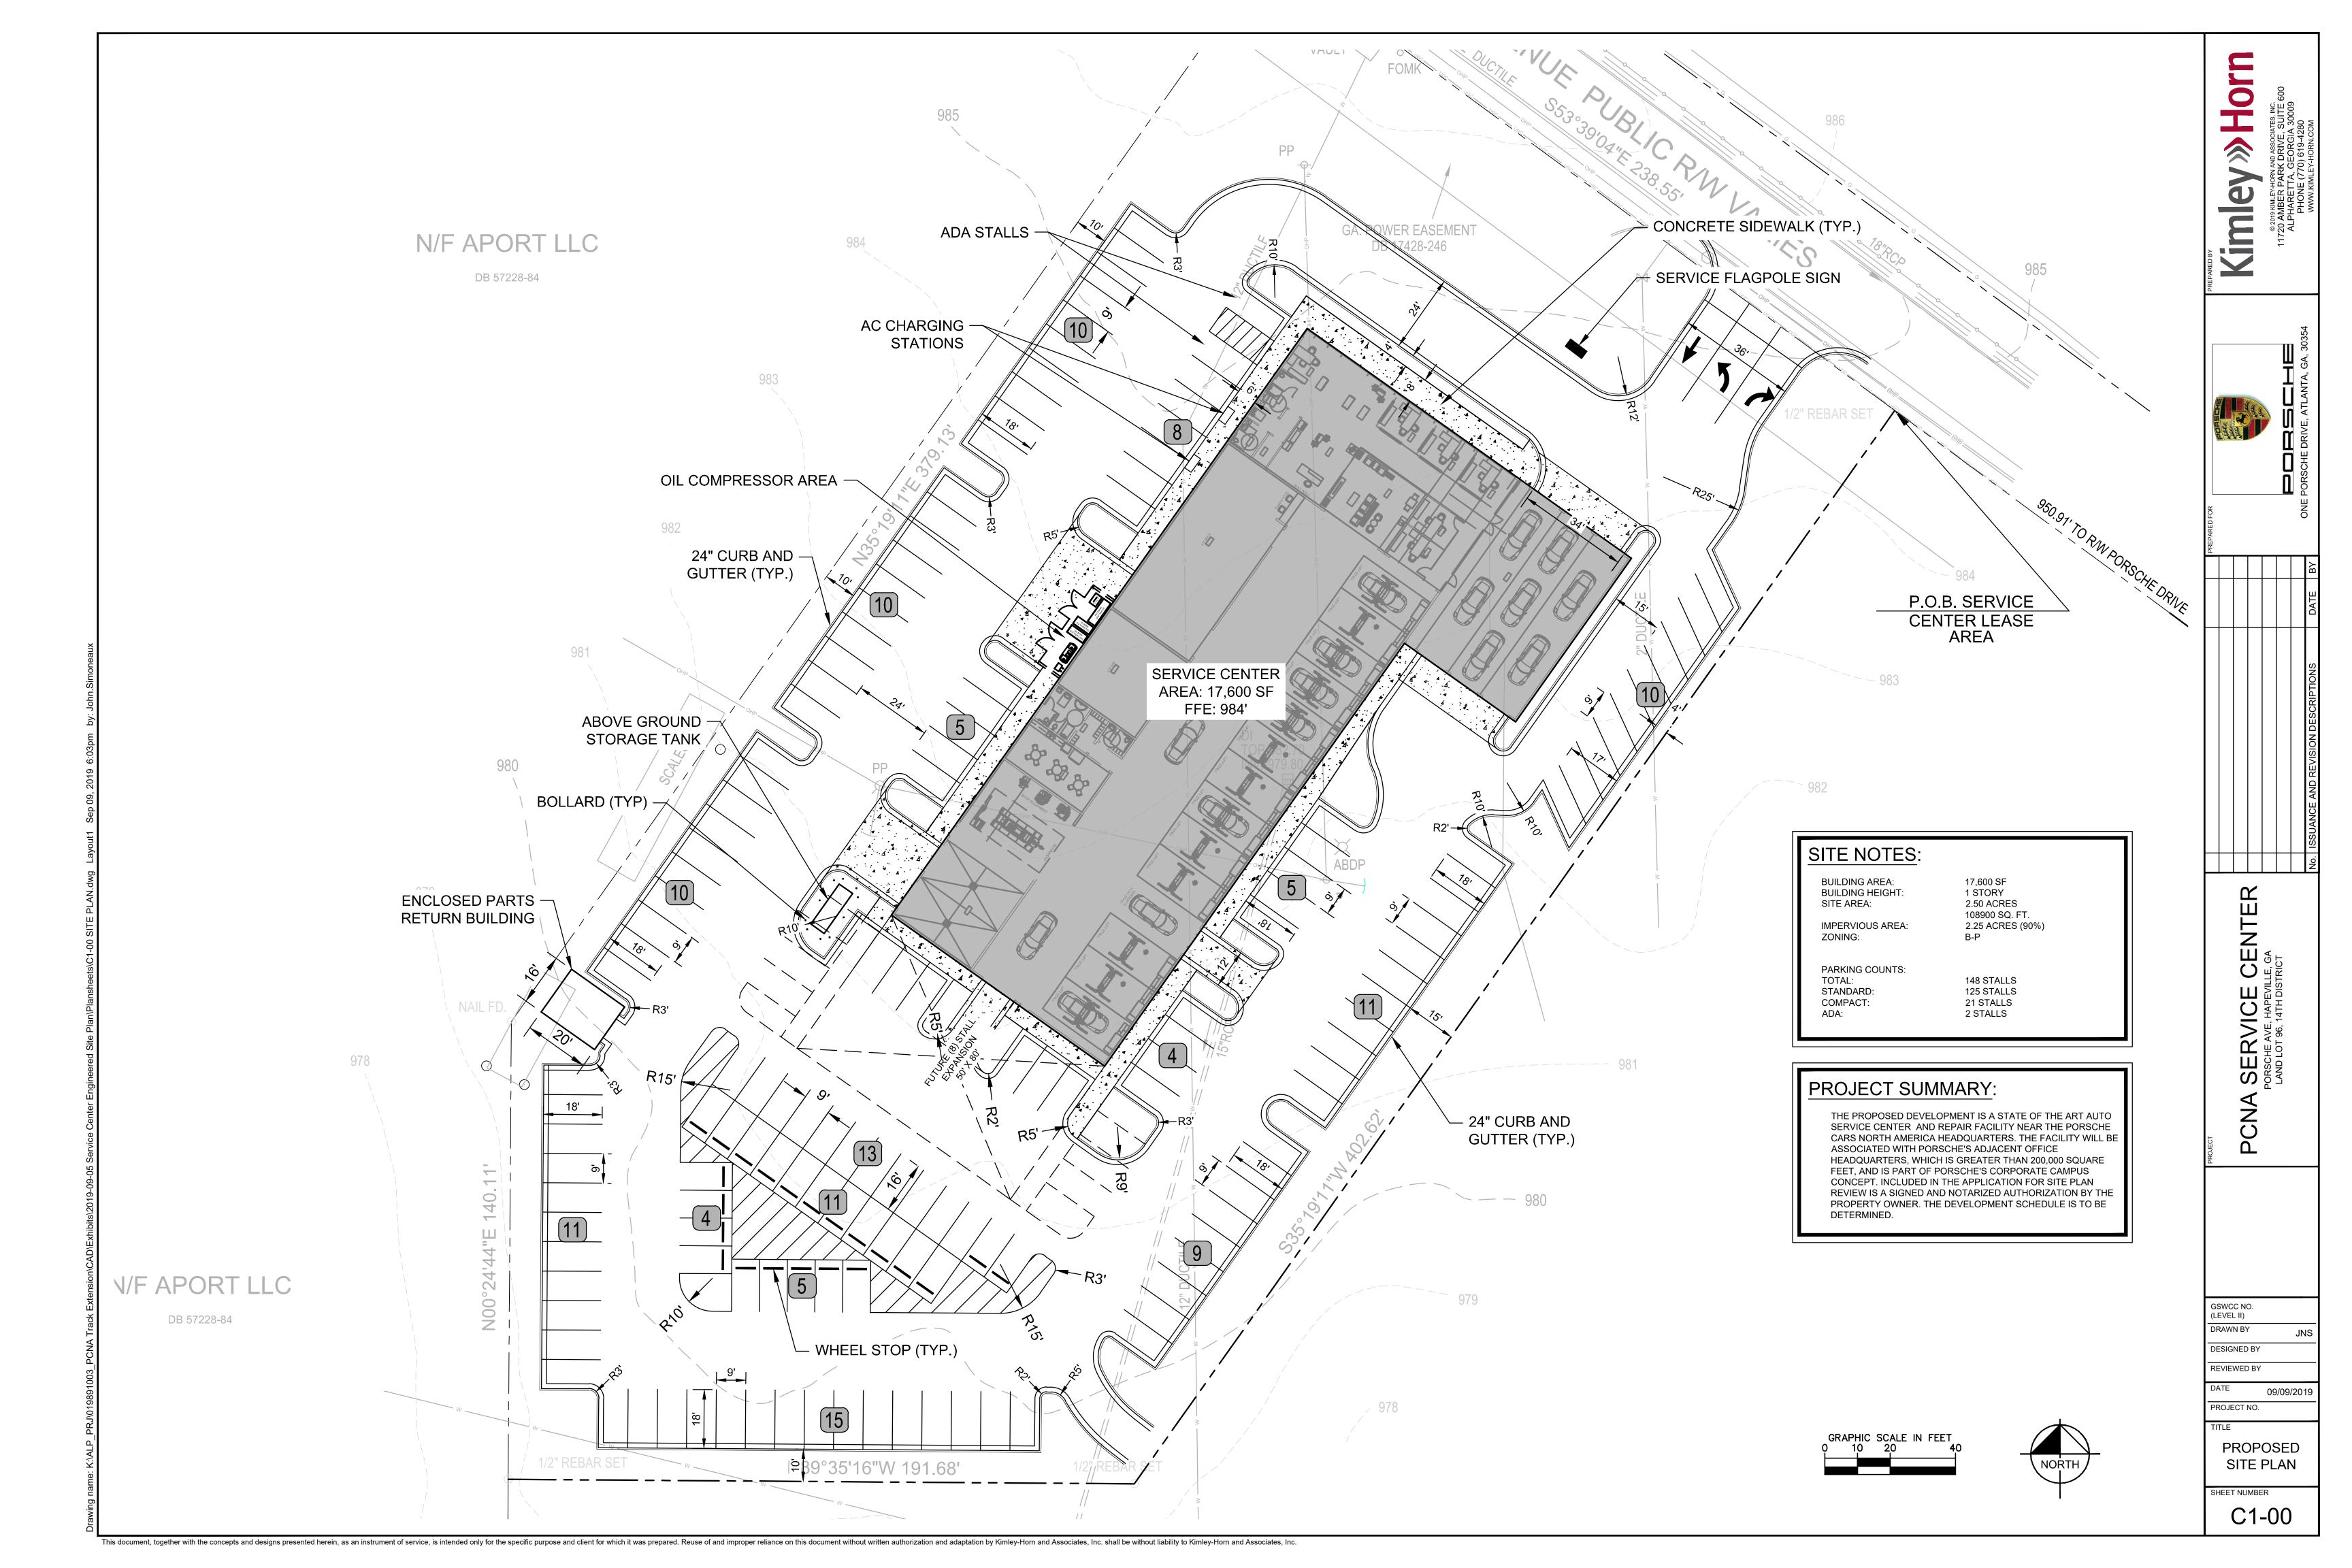
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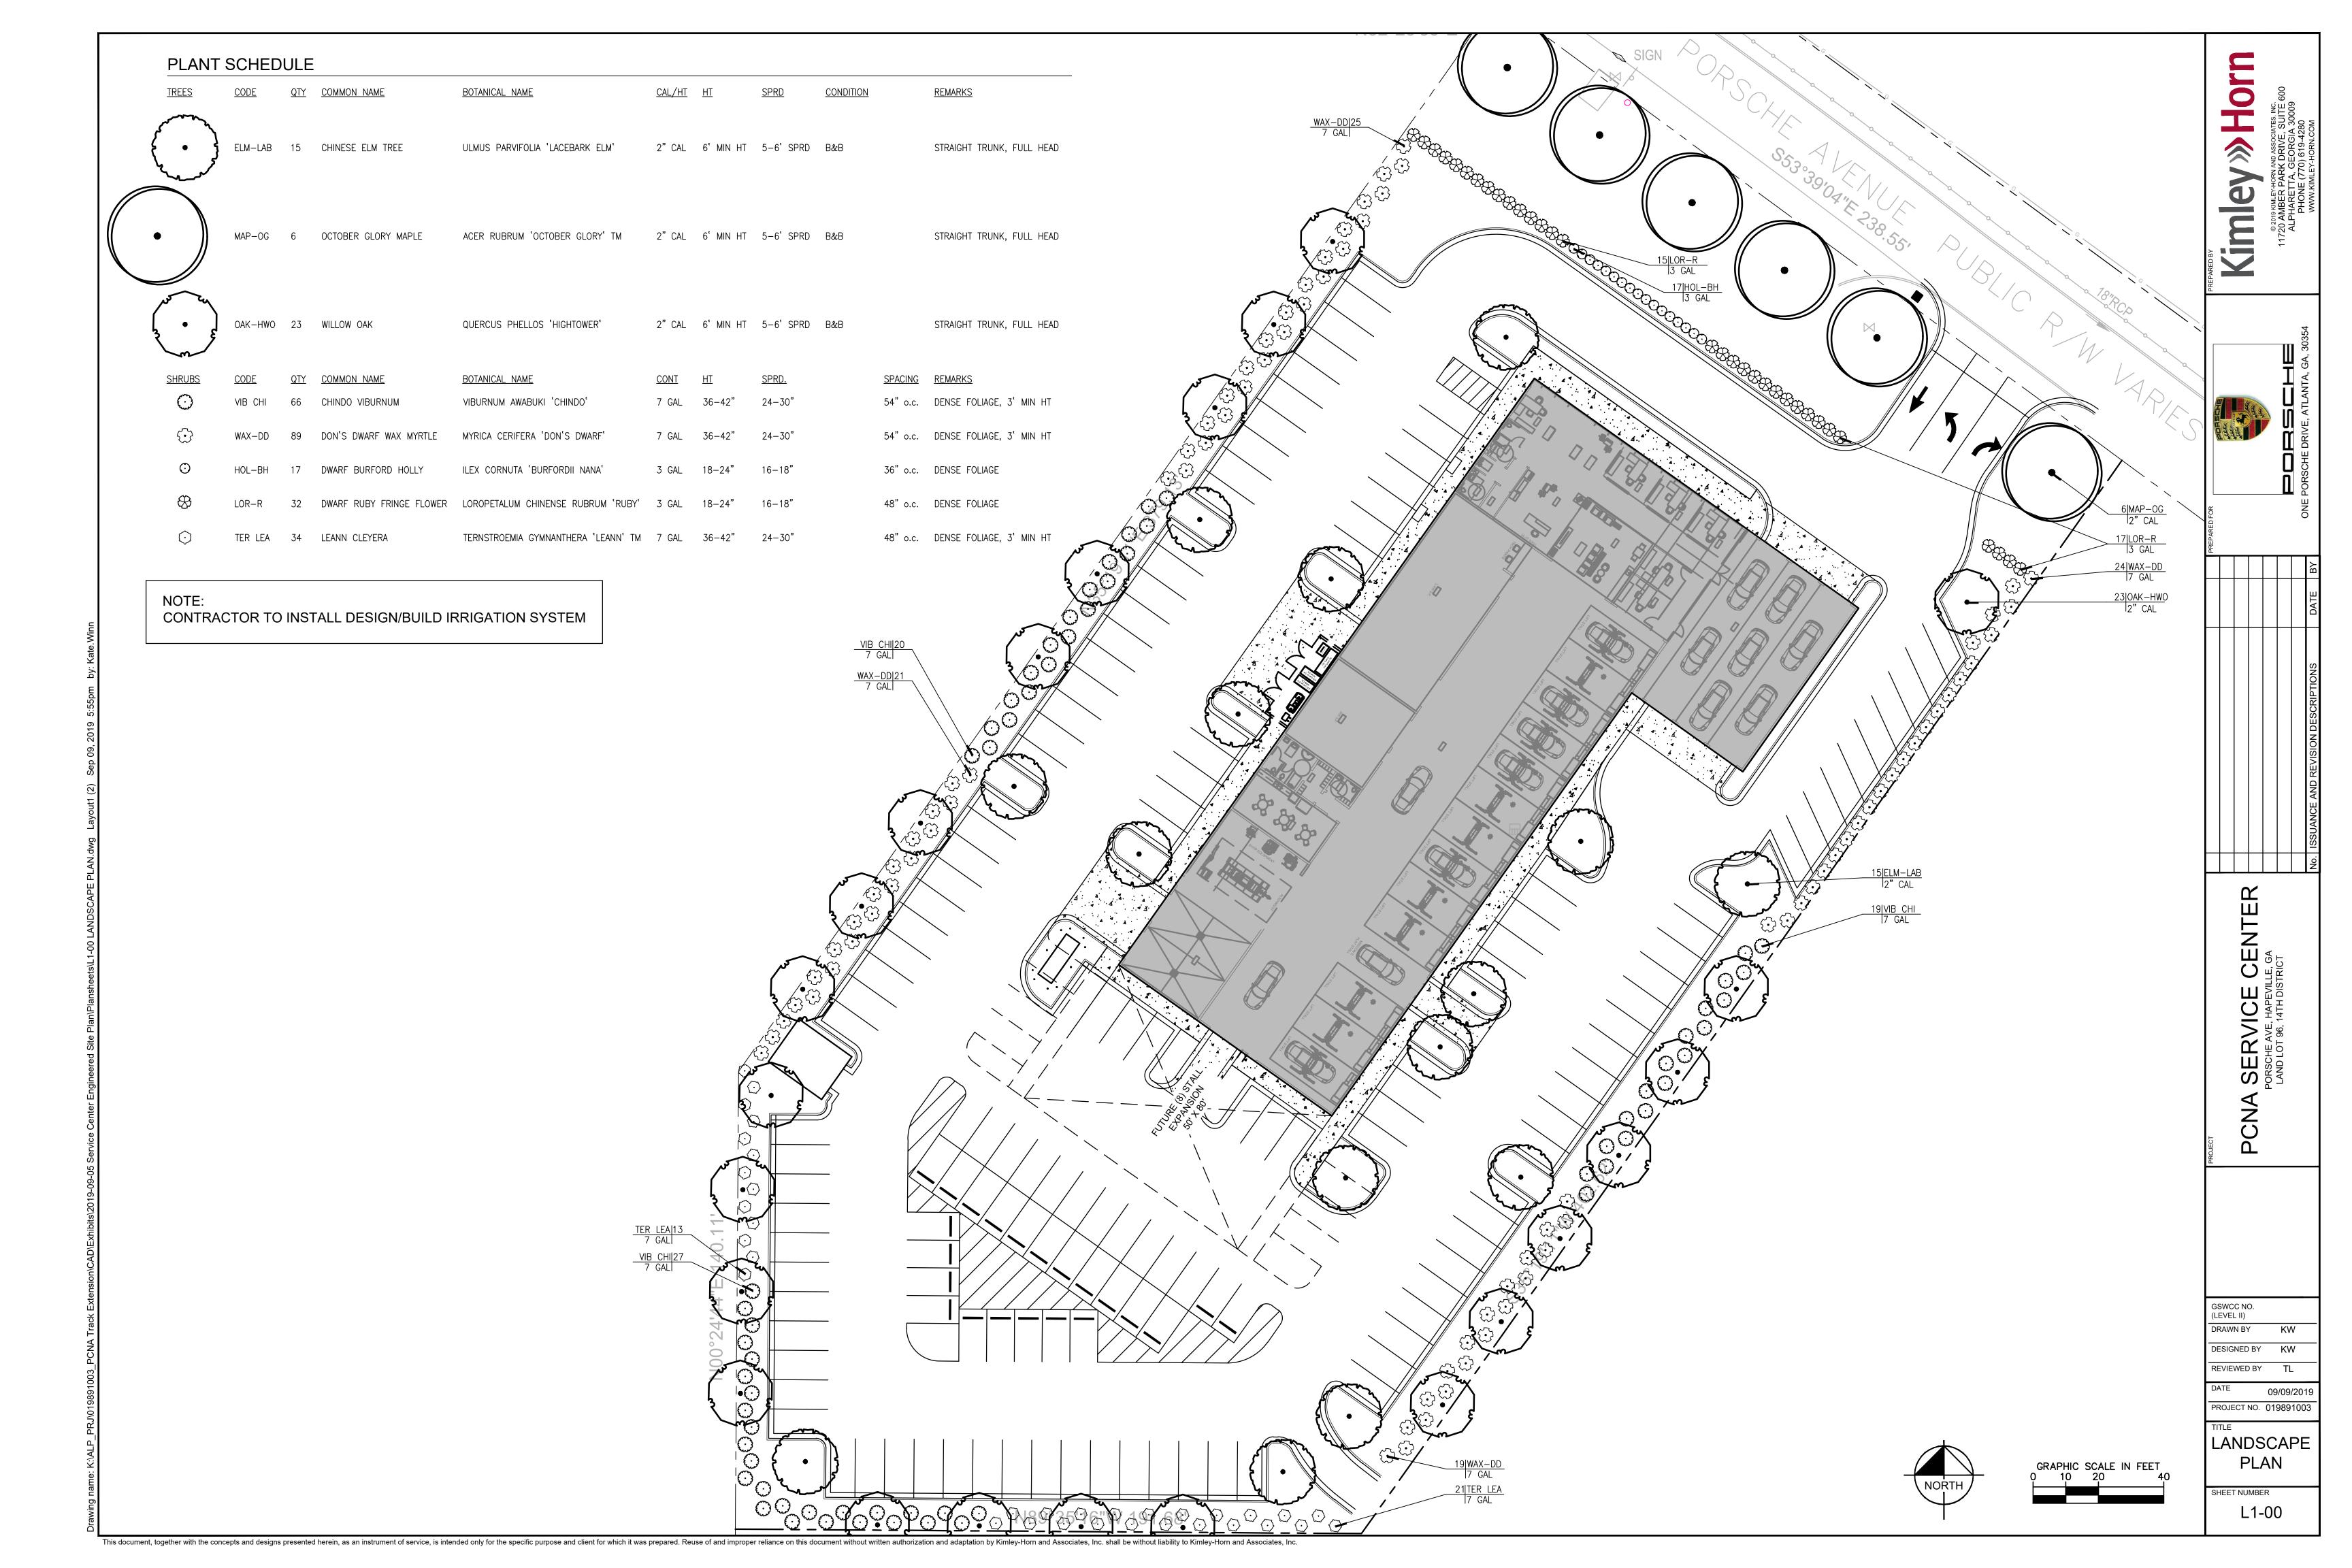
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| Part |

ENGINEERS

PORSCHE CARS
NORTH AMERICA, INC.
SERVICE CENTER LEASE AREA








Porsche Atlanta Service Center

HAPEVILLE, GA

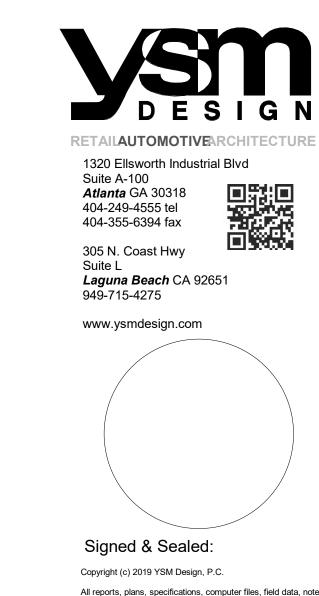

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?? CLIENT ADDRESS ??

Project:

PORSCHE ATLANTA SERVICE CENTER

SOUTH CENTRAL AVENUE HAPEVILLE, GA

HAPEVILLE, GA

Project Number: 19044
Drawn By: Author
Checked By: Checke


Checked By: Approved By: A

COVER

Sheet Number:



Signed & Sealed:

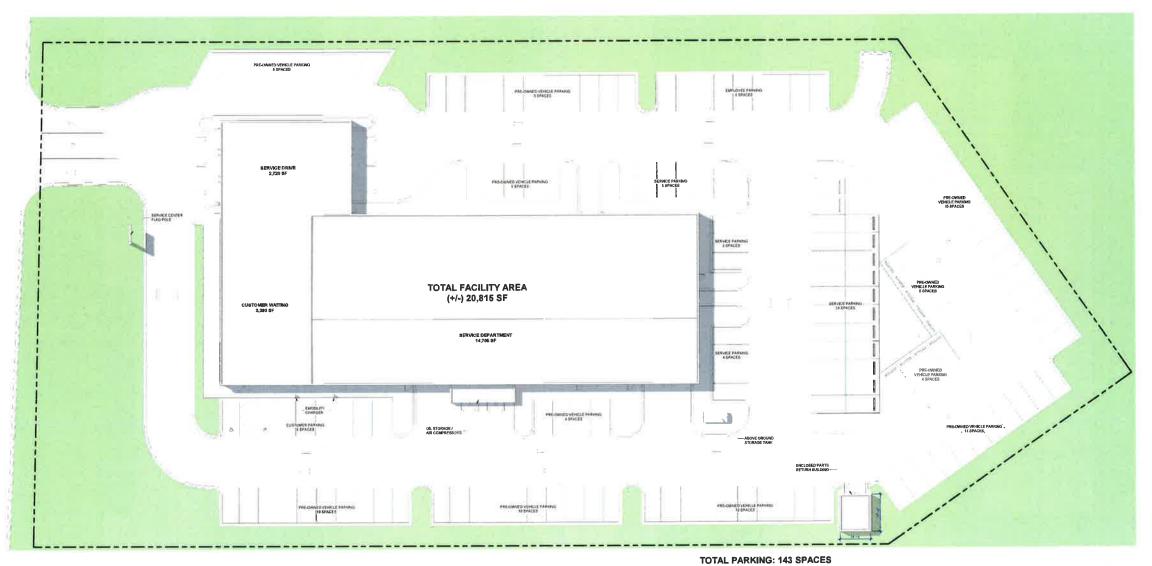




PORSCHE ATLANTA SERVICE CENTER

SOUTH CENTRAL AVENUE HAPEVILLE, GA

ARCHITECTURAL SITE PLAN

A100

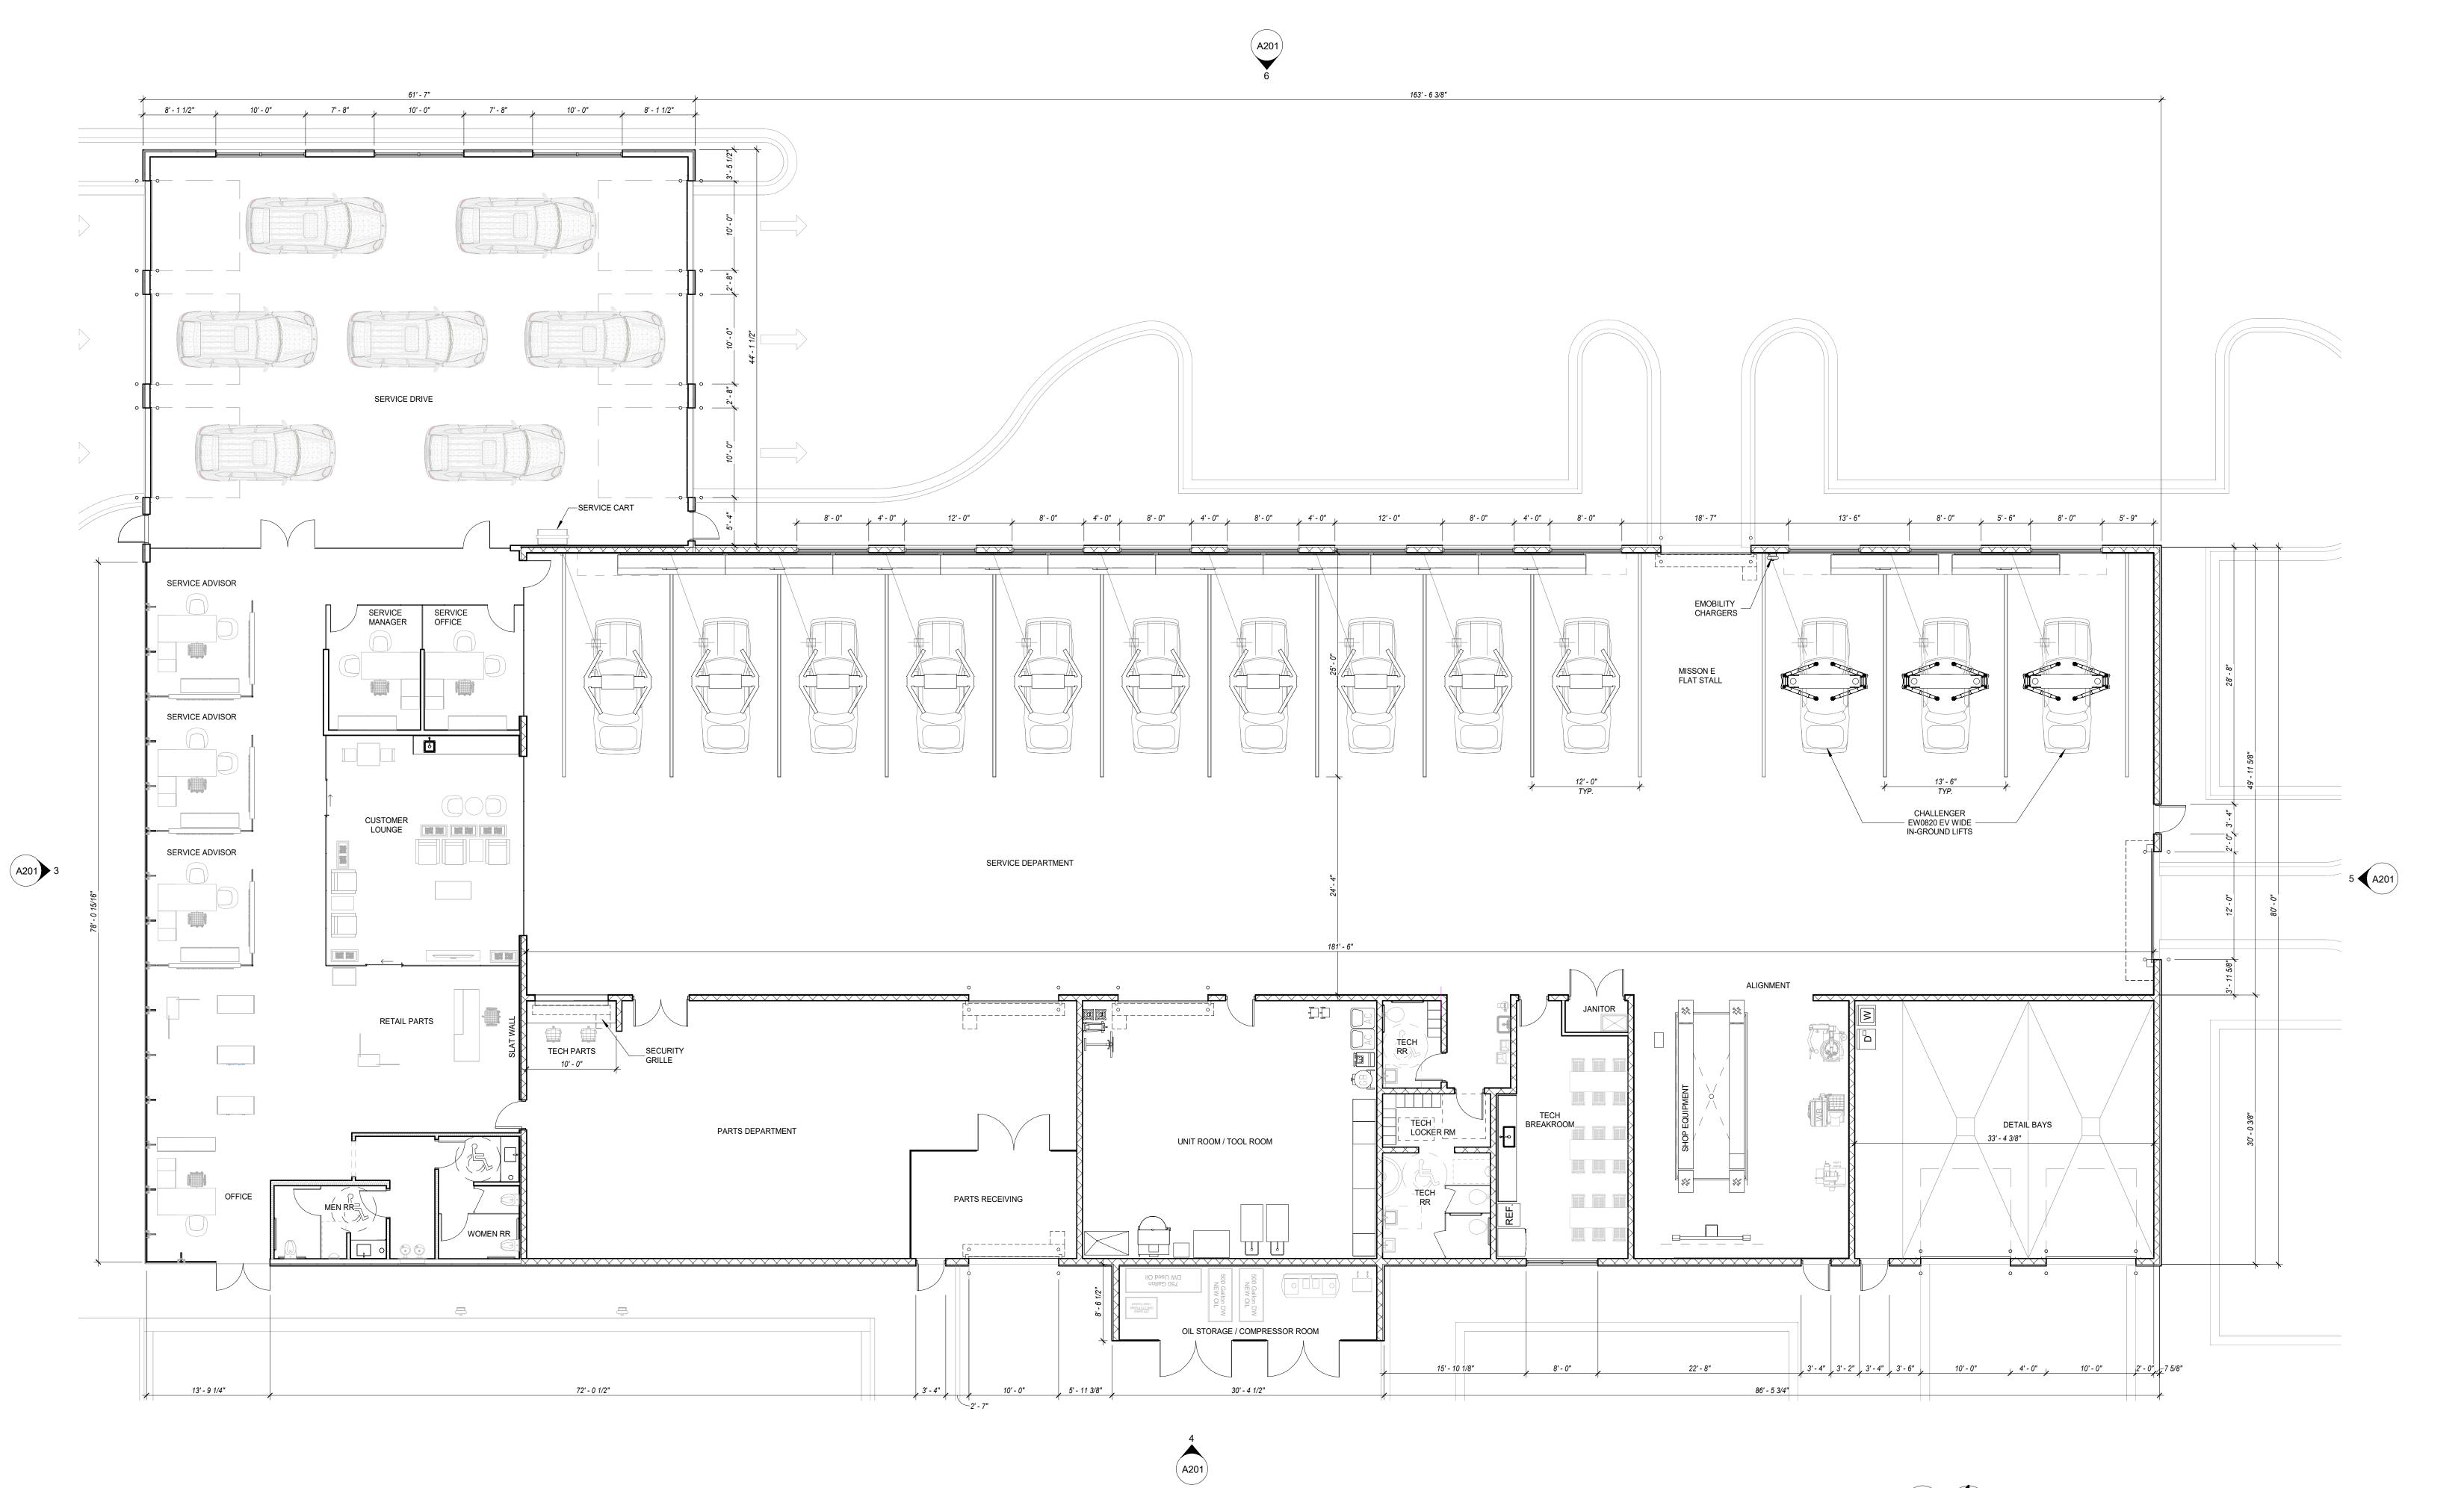



Client:

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Project:

PORSCHE ATLANTA SERVICE CENTER

SOUTH CENTRAL AVENUE HAPEVILLE, GA


Project Number: 19044
Drawn By: Author
Checked By: Checker Approved By: Approver

FLOOR PLAN

Sheet Title:


Sheet Number:

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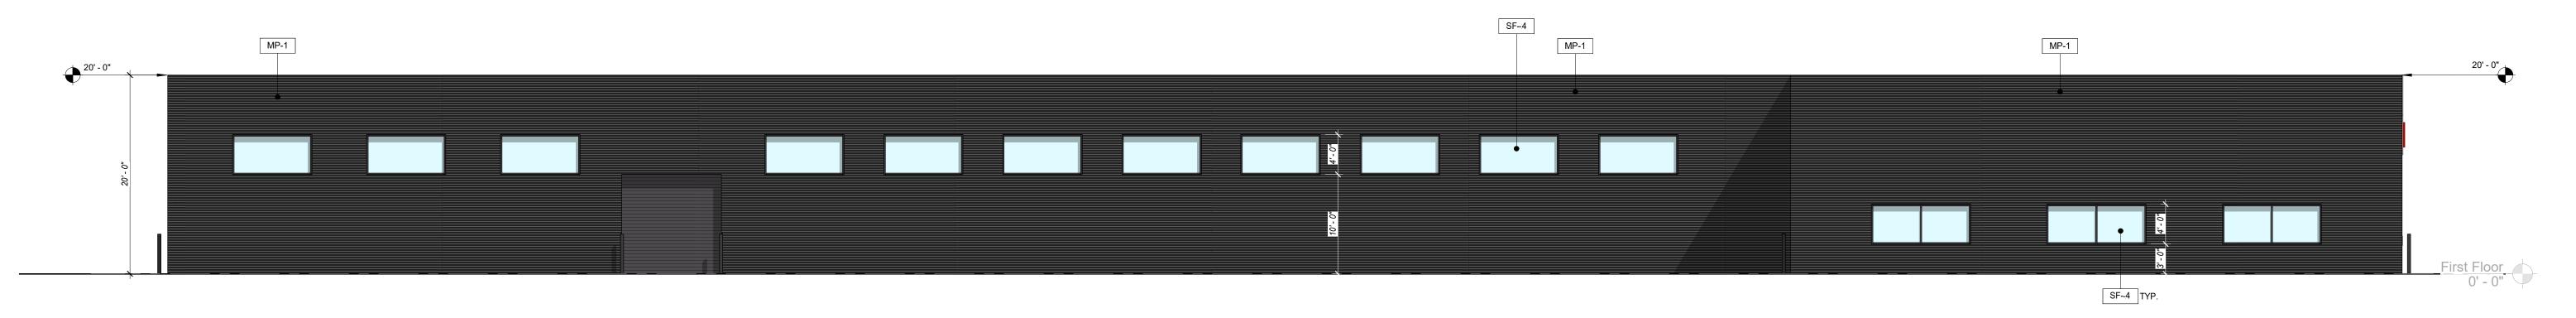


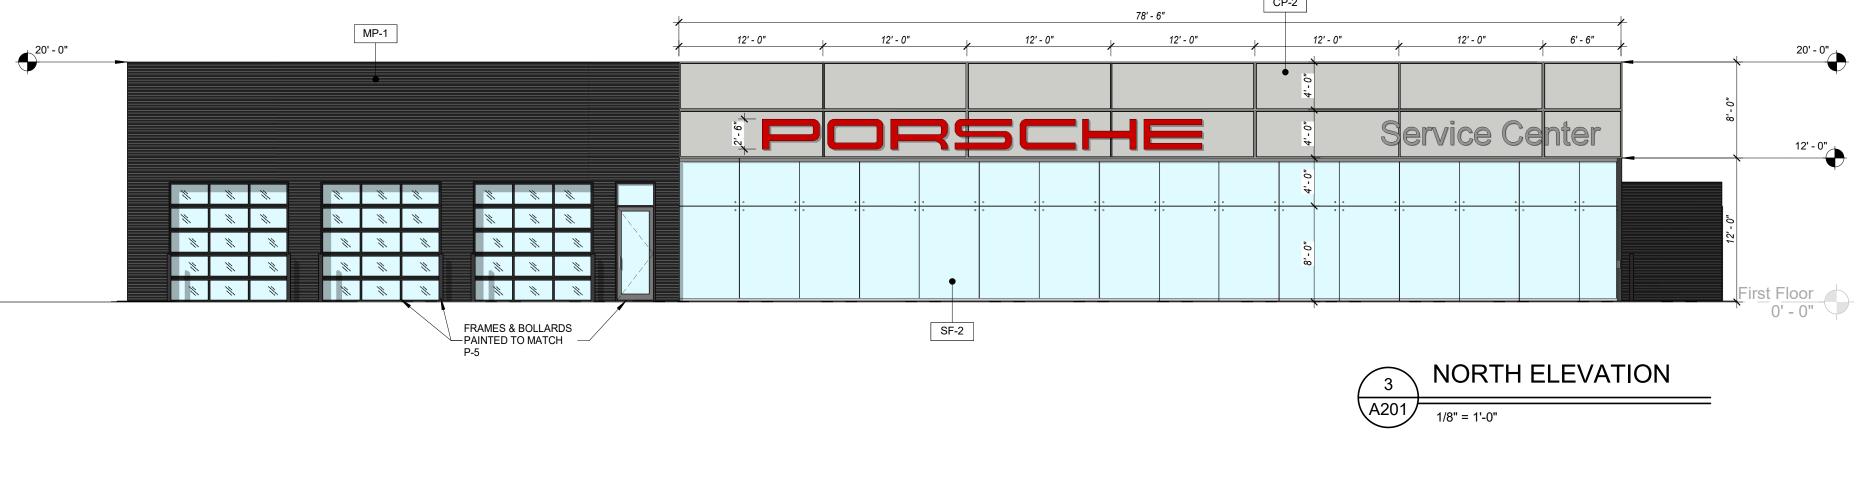






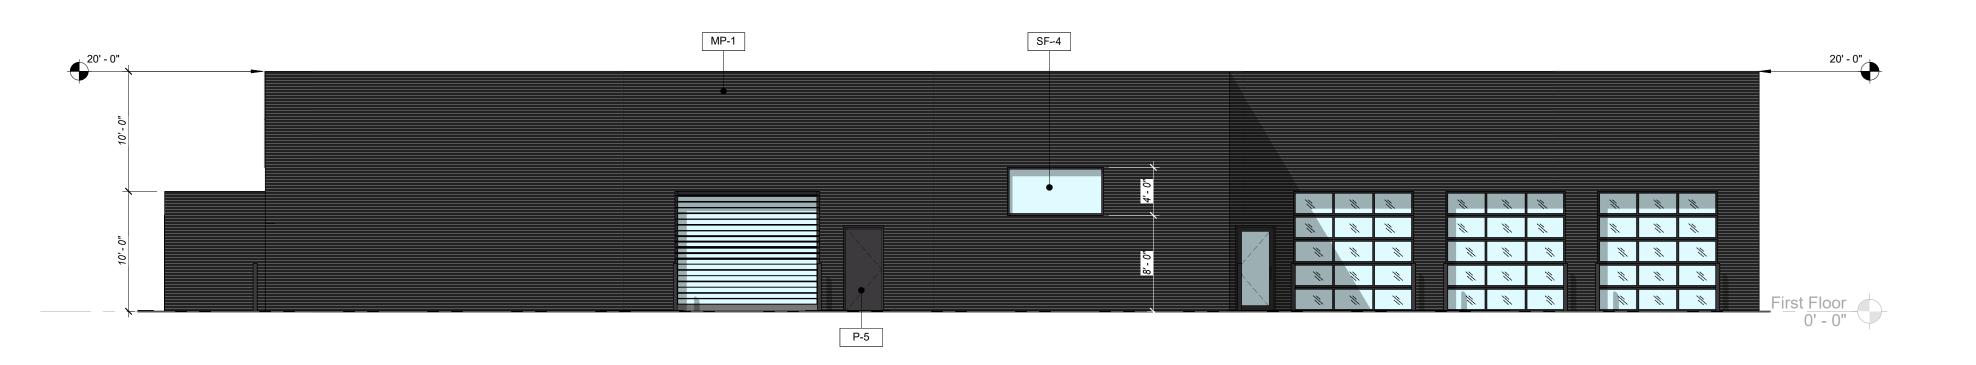



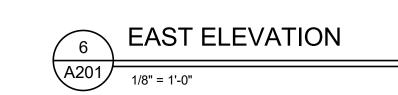

EXTERIOR FINISHES						
	CODE	MATERIAL	MANUFACTURER	PATTERN	COLOR	COMMENTS
ΙT	P-5	EXTERIOR PAINT	SHERWIN WILLIAMS	FLAT FINISH	TO MATCH RAL 7021	EXTERIOR DOORS, FRAMES & BOLLARDS
PAINT						
LS	CP-2	PERFORATED METAL PANEL	ALPOLIC BY PATTISON SIGNS		SUNRISE SILVER	ALPOLIC BY PATTISON SIGNS
META	MC-1	PRE-FINISHED METAL COPING	TBD		COLOR TO MATCH MP-1	
		ARCH. RIBBED METAL	CENTRIA	RIGID WALL #9916	ATAS TARGA BLACK (TO MATCH RAL 7021)	
NG	SF-2	STRUCTURAL CURTAINWALL	SLIMPACT		BLACK SEALANT AT VERTICAL JOINTS	FRAMELESS, STACK WALL
GLAZI	SF-2 SF-4	EXTERIOR STOREFRONT	KAWNEER	451T	TO MATCH MP-1	





Client: Client Name Here ? ?? CLIENT ADDRESS ??

Project:

PORSCHE ATLANTA SERVICE CENTER

SOUTH CENTRAL AVENUE HAPEVILLE, GA

Project Number: 19044
Drawn By: FB Checked By: AA
Approved By: YSM

Sheet Title: BUILDING

ELEVATIONS Sheet Number:











DESIGN BUILD CONTRACTORS

Client Name Here ?

?? CLIENT ADDRESS ??

Project:

Client:

PORSCHE ATLANTA SERVICE CENTER

SOUTH CENTRAL AVENUE HAPEVILLE, GA

Project Number: 19044
Drawn By: Author
Checked By: Checker
Approved By: Approver

Sheet Title:

EXTERIOR 3D

VIEWS

Sheet Number:

A205



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PORSCHE ATLANTA SERVICE CENTER


SOUTH CENTRAL AVENUE HAPEVILLE, GA

Project Number: 19044
Drawn By: Author
Checked By: Checker
Approved By: Approver

RENDERING

Sheet Title:

Sheet Number:

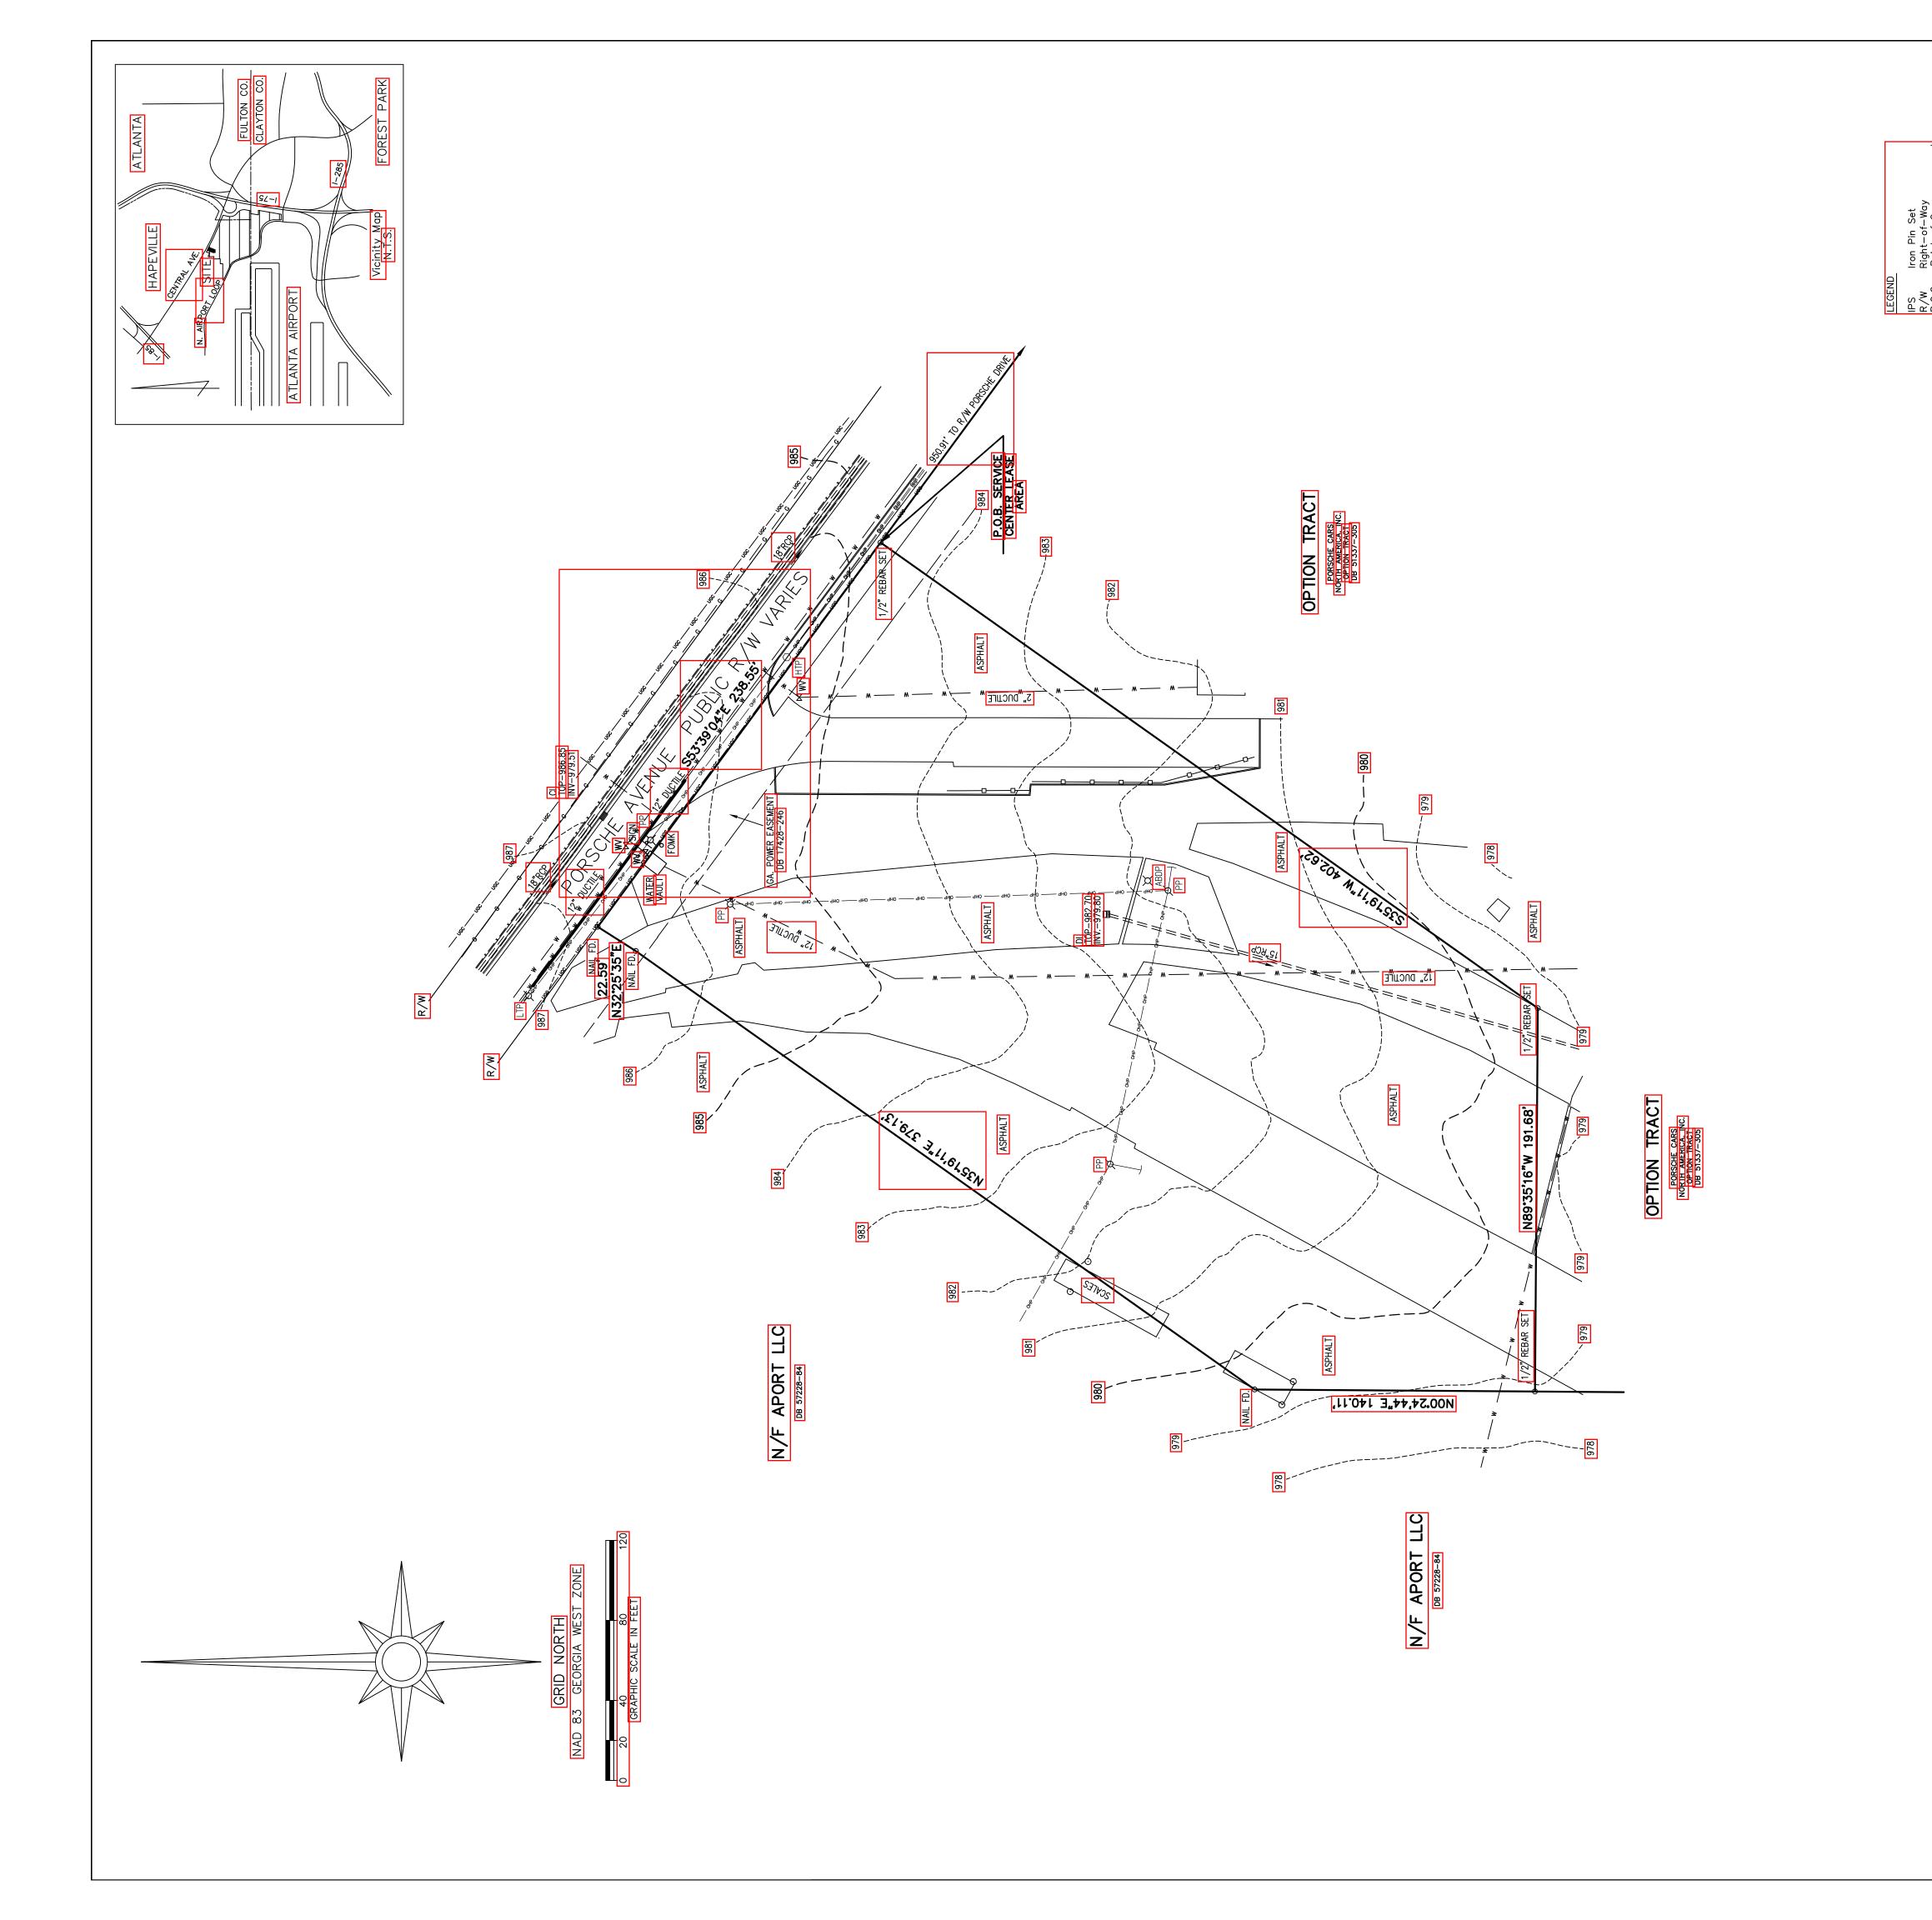

SERVICE CENTER LEASE

FEGEND SINGLE STATE OF STATE

